
### SATELLITE MAP - No Scale

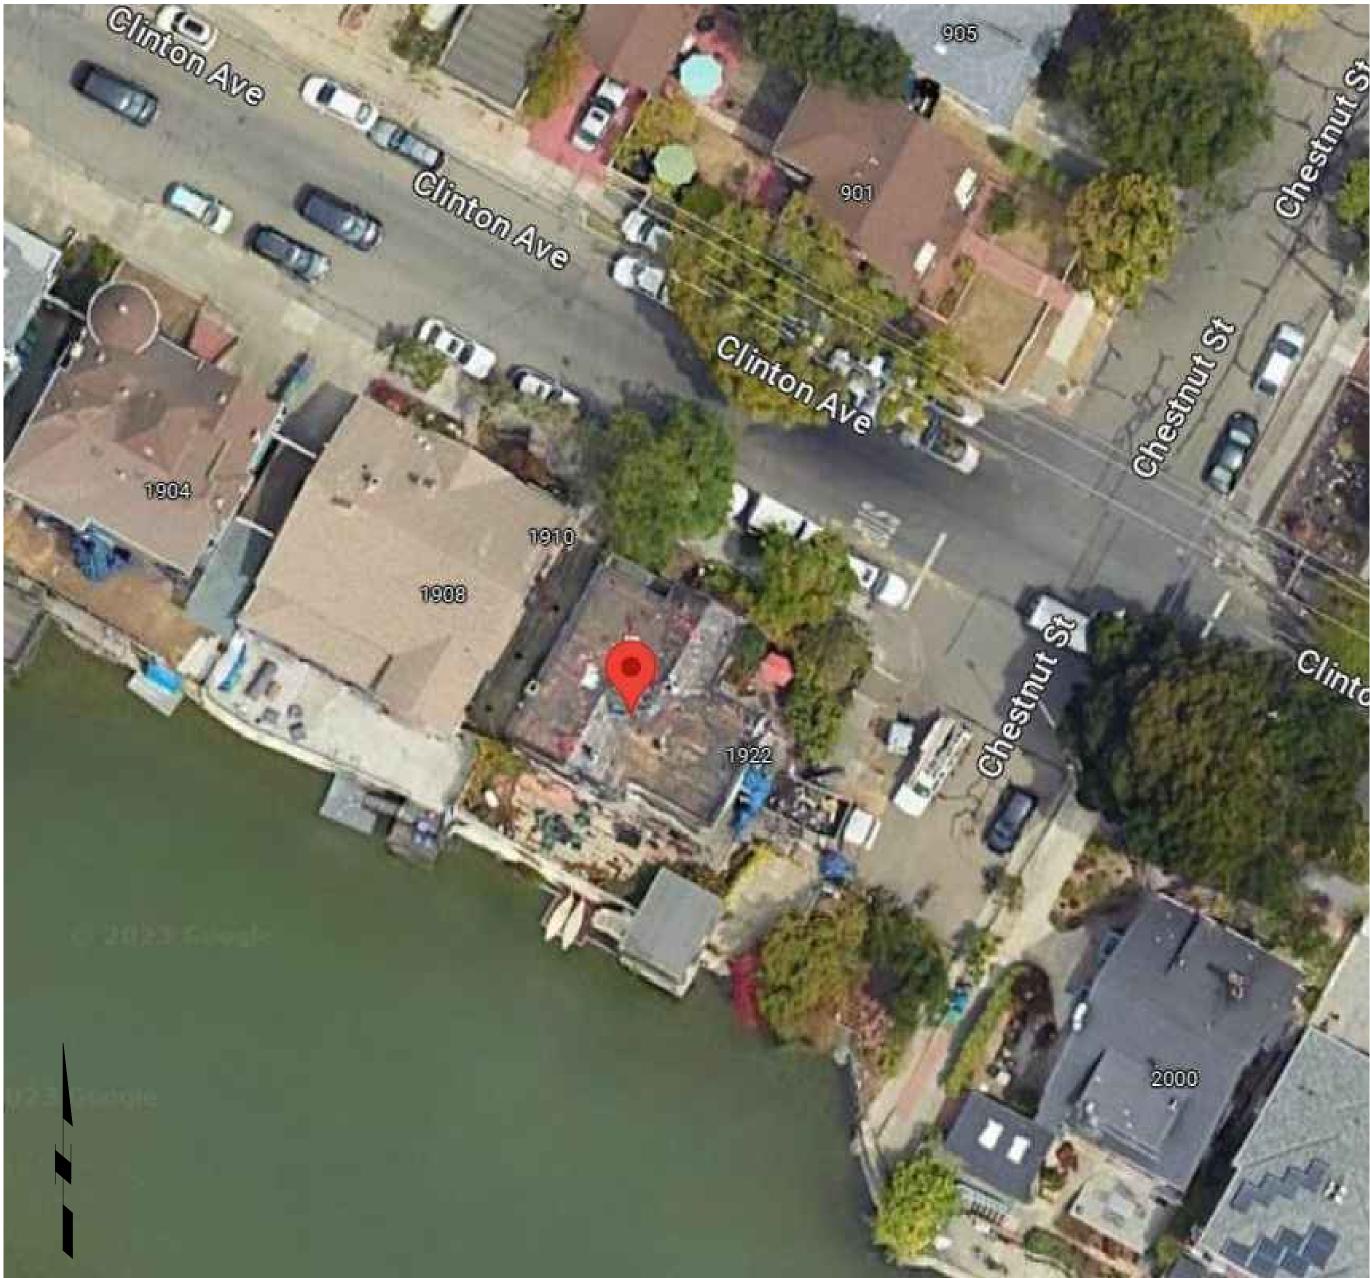

### SCOPE OF WORK

#### New / Proposed Mork:

- The current property is an existing 2-unit multi-family residence. Per the City of Alameda permit history: Bldg. Permit # 897-0122, dated 1/30/1997, states "2 Units per City (Prequalif. Amnesty)"
- Create two new ADUs: a 1-bedroom and a 2-bedroom at the existing non-habitable basement level of the building. In order to attain adequate, code compliant ceiling height in these units, we propose raising the entire building (2'-6") above the existing grade.
- As part of this work, all existing exterior stairs will be modified with extra treads and risers in order to reach the upper floors, which will be (2'-6'') higher above grade.
- Miscellaneous proposed site modifications include: 1. Adding a new metal gate at the Chestnut St. side of the property.
  - 2. Modifying the existing planter at the driveway side of the property to allow for a continuous concrete walkway from the sidewalk along the entire length of the driveway.

# DRAWING LIST

#### Architectural

C1.0 Cover Sheet: Project Info., Scope of Work, Vicinity Map, Satellite Map, Drawing List, Applicable Codes

A1.0 Existing Site Plan
A1.1 Proposed Site Plan

A2.0 Existing & Proposed Basement Floor Plans
A2.1 Existing 1st & 2nd Floor Plans
A2.2 Existing Roof Plan
A2.3 Window & Door Schedule & Details

A3.0 Existing & Proposed Front Exterior Elevations
A3.1 Existing & Proposed Chestnut St. Exterior Elevations

A3.2 Existing & Proposed Rear Exterior Elevations A3.3 Existing & Proposed Driveway Exterior Elevations

412 Shrader St., San Francisco, CA 94117 415.346.1572

1516 Oak St. #108, Alameda, CA 94502 510.697.0224

### PROJECT TEAM

#### Owners:

Duy Nguyen and Hai Pham 1912 Clinton Avenue Alameda, CA 94501 Tel: (510) 409-2479

#### Architect:

Acanthus Architecture & Design 412 Shrader Street San Francisco, CA 94117 Tel: (415) 346-1572


These drawings and specifications are the property of Acanthus Architecture + Design. The information on these drawings is for use solely with respect to this project and shall not be used otherwise without the written consent of Acanthus Architecture + Design.

These drawings are neither final nor are they to be used for construction until they are signed by the Architect and approved by the Building Department.

Issued for Prelim. 11-22-23 Planning Review

Issued for Planning Review 1-22-23

↑ Planning Review Revision#1 3-7-23

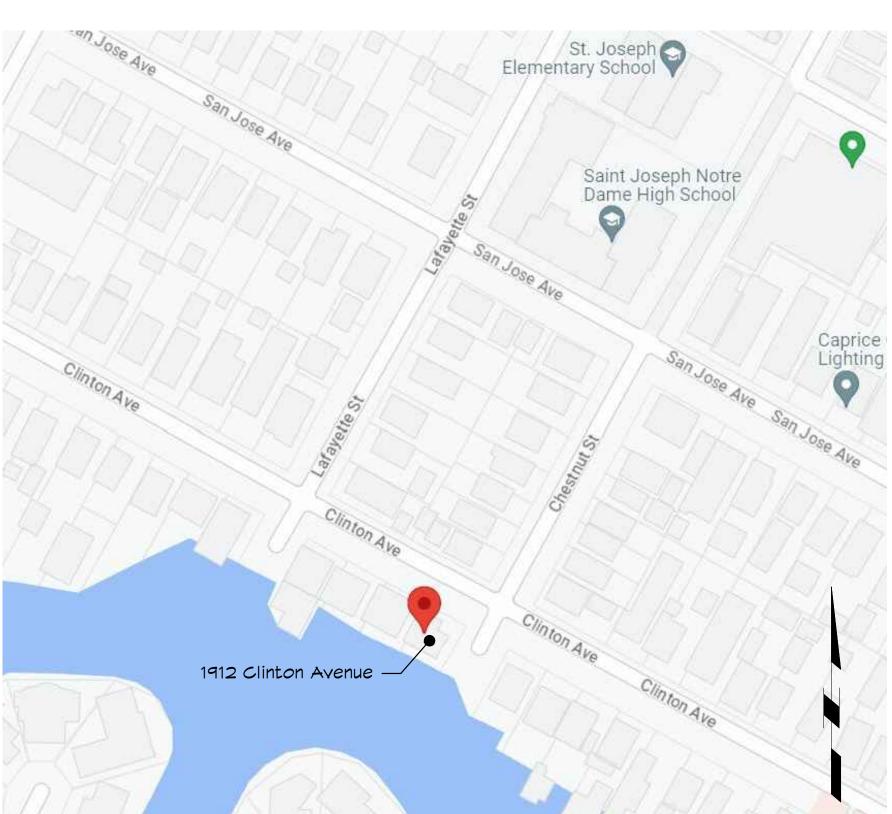

### APPLICABLE CODES

#### All Mork Shall Comply With:

2019 California Building Code 2019 California Residential Code 2019 California Electrical Code 2019 California Mechanical Code

2019 California Plumbing Code

2019 California Energy Code 2019 California Fire Code, with local amendments

UNIT CALCULATIONS

Unit 2

Total

Existing

2,051 s.f.

492 s.f.

2,543 s.f.

Proposed

2,051 s.f.

492 s.f.

527 s.f.

812 s.f.

3,882 s.f.

2019 CalGreen Building Standards Code

2019 California Referenced Standards Code All Applicable City of Alameda Ordinances.

1912 Clinton Avenue Alameda, CA 94501

**CLINTON AVE.** 


**REMODEL** 


GENERAL NOTES

November 20, 2023

JOB NO.

© COPYRIGHT 2024 ACANTHUS ARCHITECTURE & DESIGN

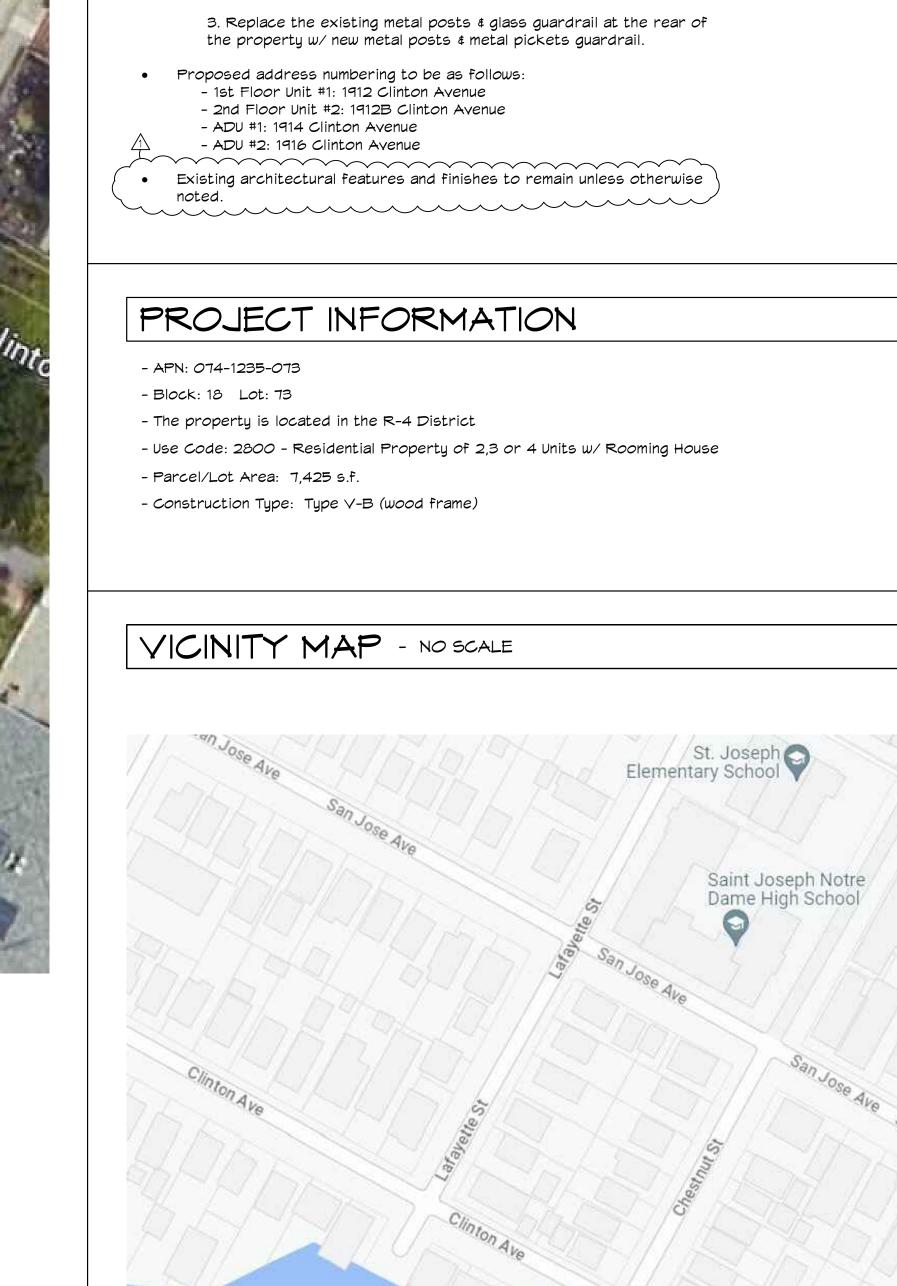

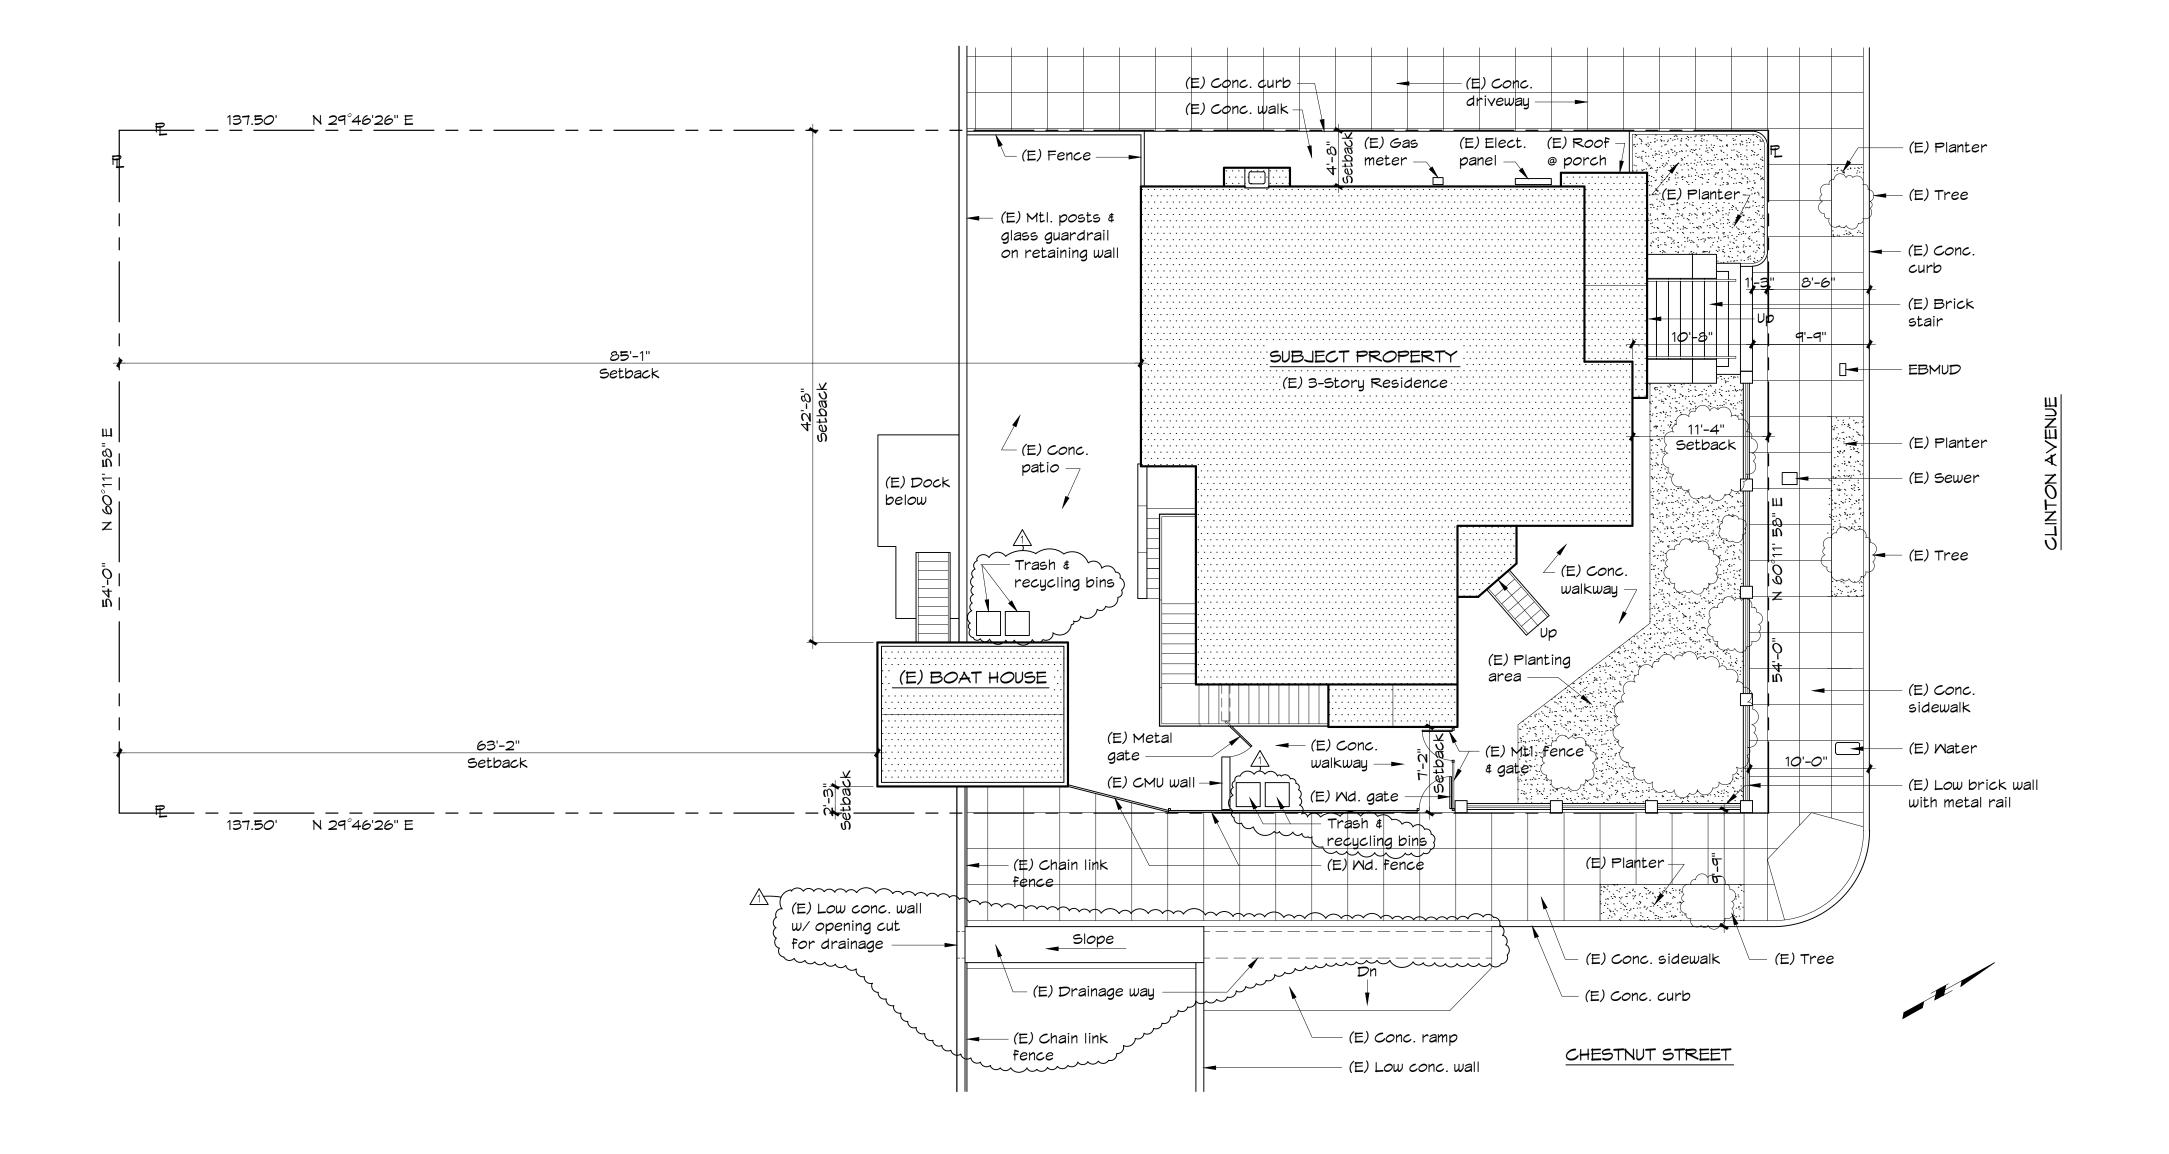



A1.0) SCALE: 1/8" = 1'-0"



412 Shrader St., San Francisco, CA 94117 415.346.1572

1516 Oak St. #108, Alameda, CA 94502 510.697.0224



These drawings and specifications are the property of Acanthus Architecture + Design. The information on these drawings is for use solely with respect to this project and shall not be used otherwise without the written consent of Acanthus Architecture + Design.

These drawings are neither final nor are they to be used for construction until they are signed by the Architect and approved by the Building Department.

| KEVIOTO                               | 27 (    |
|---------------------------------------|---------|
| lssued for Prelim.<br>Planning Review | 11-22-2 |
| Issued for Planning Review            | 1-22-2  |

↑ Planning Review Revision#1 3-7-23

# CLINTON AVE. REMODEL


1912 Clinton Avenue Alameda, CA 94501

DRAWING TITLE

EXISTING SITE PLAN

|     | SCALE      | 1/4" = 1'-0"      |  |
|-----|------------|-------------------|--|
|     | DATE       | Oct. 31, 2023     |  |
|     | DRAWN BY   | DPM               |  |
|     | JOB NO.    |                   |  |
| - 1 | DRAWING NO | <del></del><br>Э. |  |

A1.0

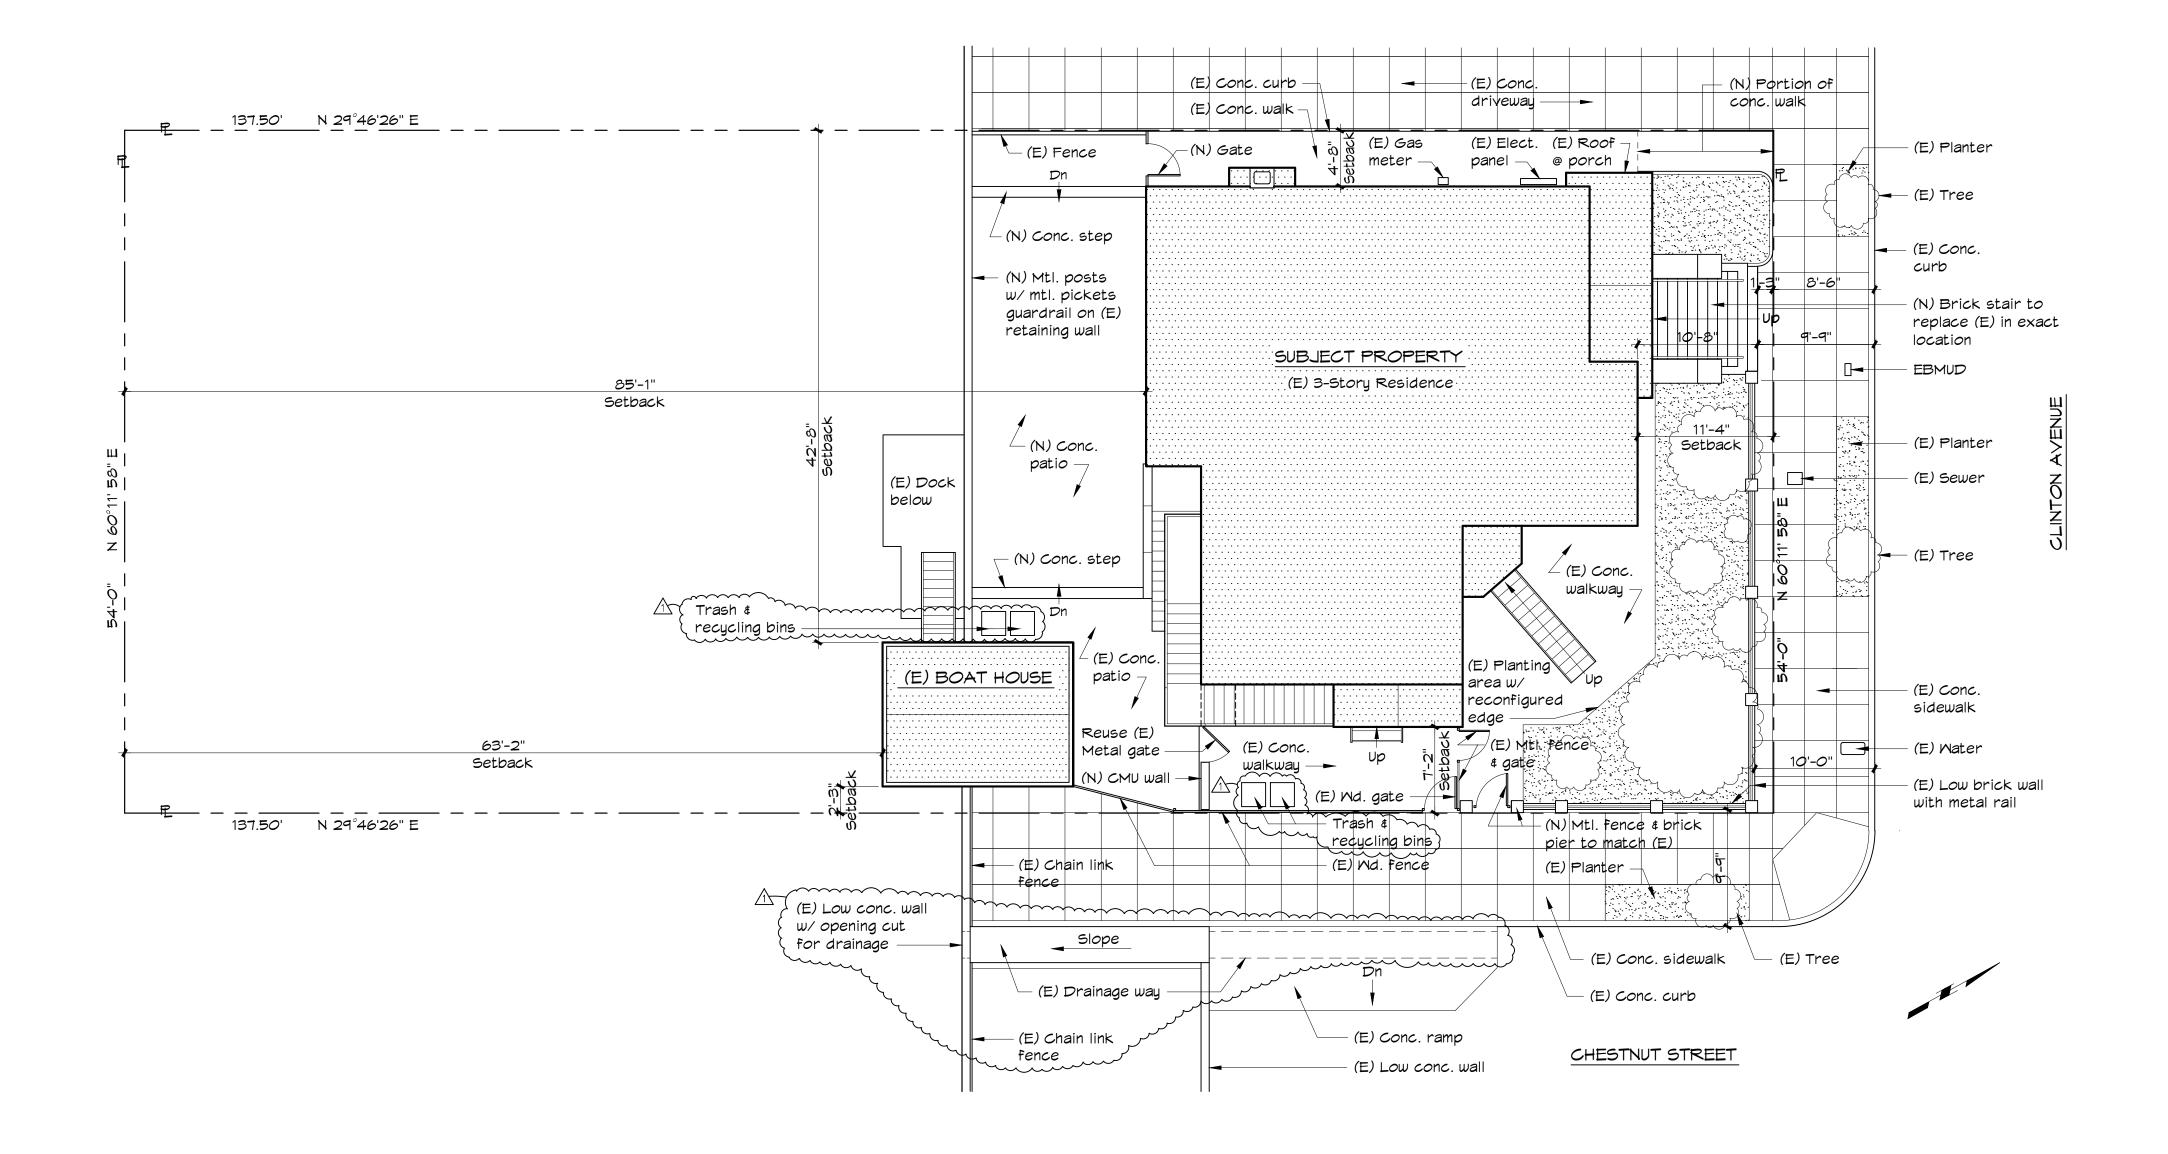

PROPOSED SITE PLAN

A1.1) SCALE: 1/8" = 1'-0"

ACANTHUS
ARCHITECTURE + DESIGN

412 Shrader St., San Francisco, CA 94117 415.346.1572

1516 Oak St. #108, Alameda, CA 94502 510.697.0224



These drawings and specifications are the property of Acanthus Architecture + Design. The information on these drawings is for use solely with respect to this project and shall not be used otherwise without the written consent of Acanthus Architecture + Design.

These drawings are neither final nor are they to be used for construction until they are signed by the Architect and approved by the Building Department.

| Issued for Prelim.<br>Planning Review | 11-22-2 |
|---------------------------------------|---------|
| Issued for Planning Review            | 1-22-2  |
|                                       |         |

Planning Review Revision#1 3-7-23

# CLINTON AVE. REMODEL


1912 Clinton Avenue Alameda, CA 94501

DRAWING TITLE

PROPOSED SITE PLAN

| SCALE     | 1/4" = 1'-0"  |
|-----------|---------------|
| DATE      | Oct. 31, 2023 |
| DRAWN BY  | DPM           |
| JOB NO.   |               |
| DRAWING N | Ο.            |

A1.1

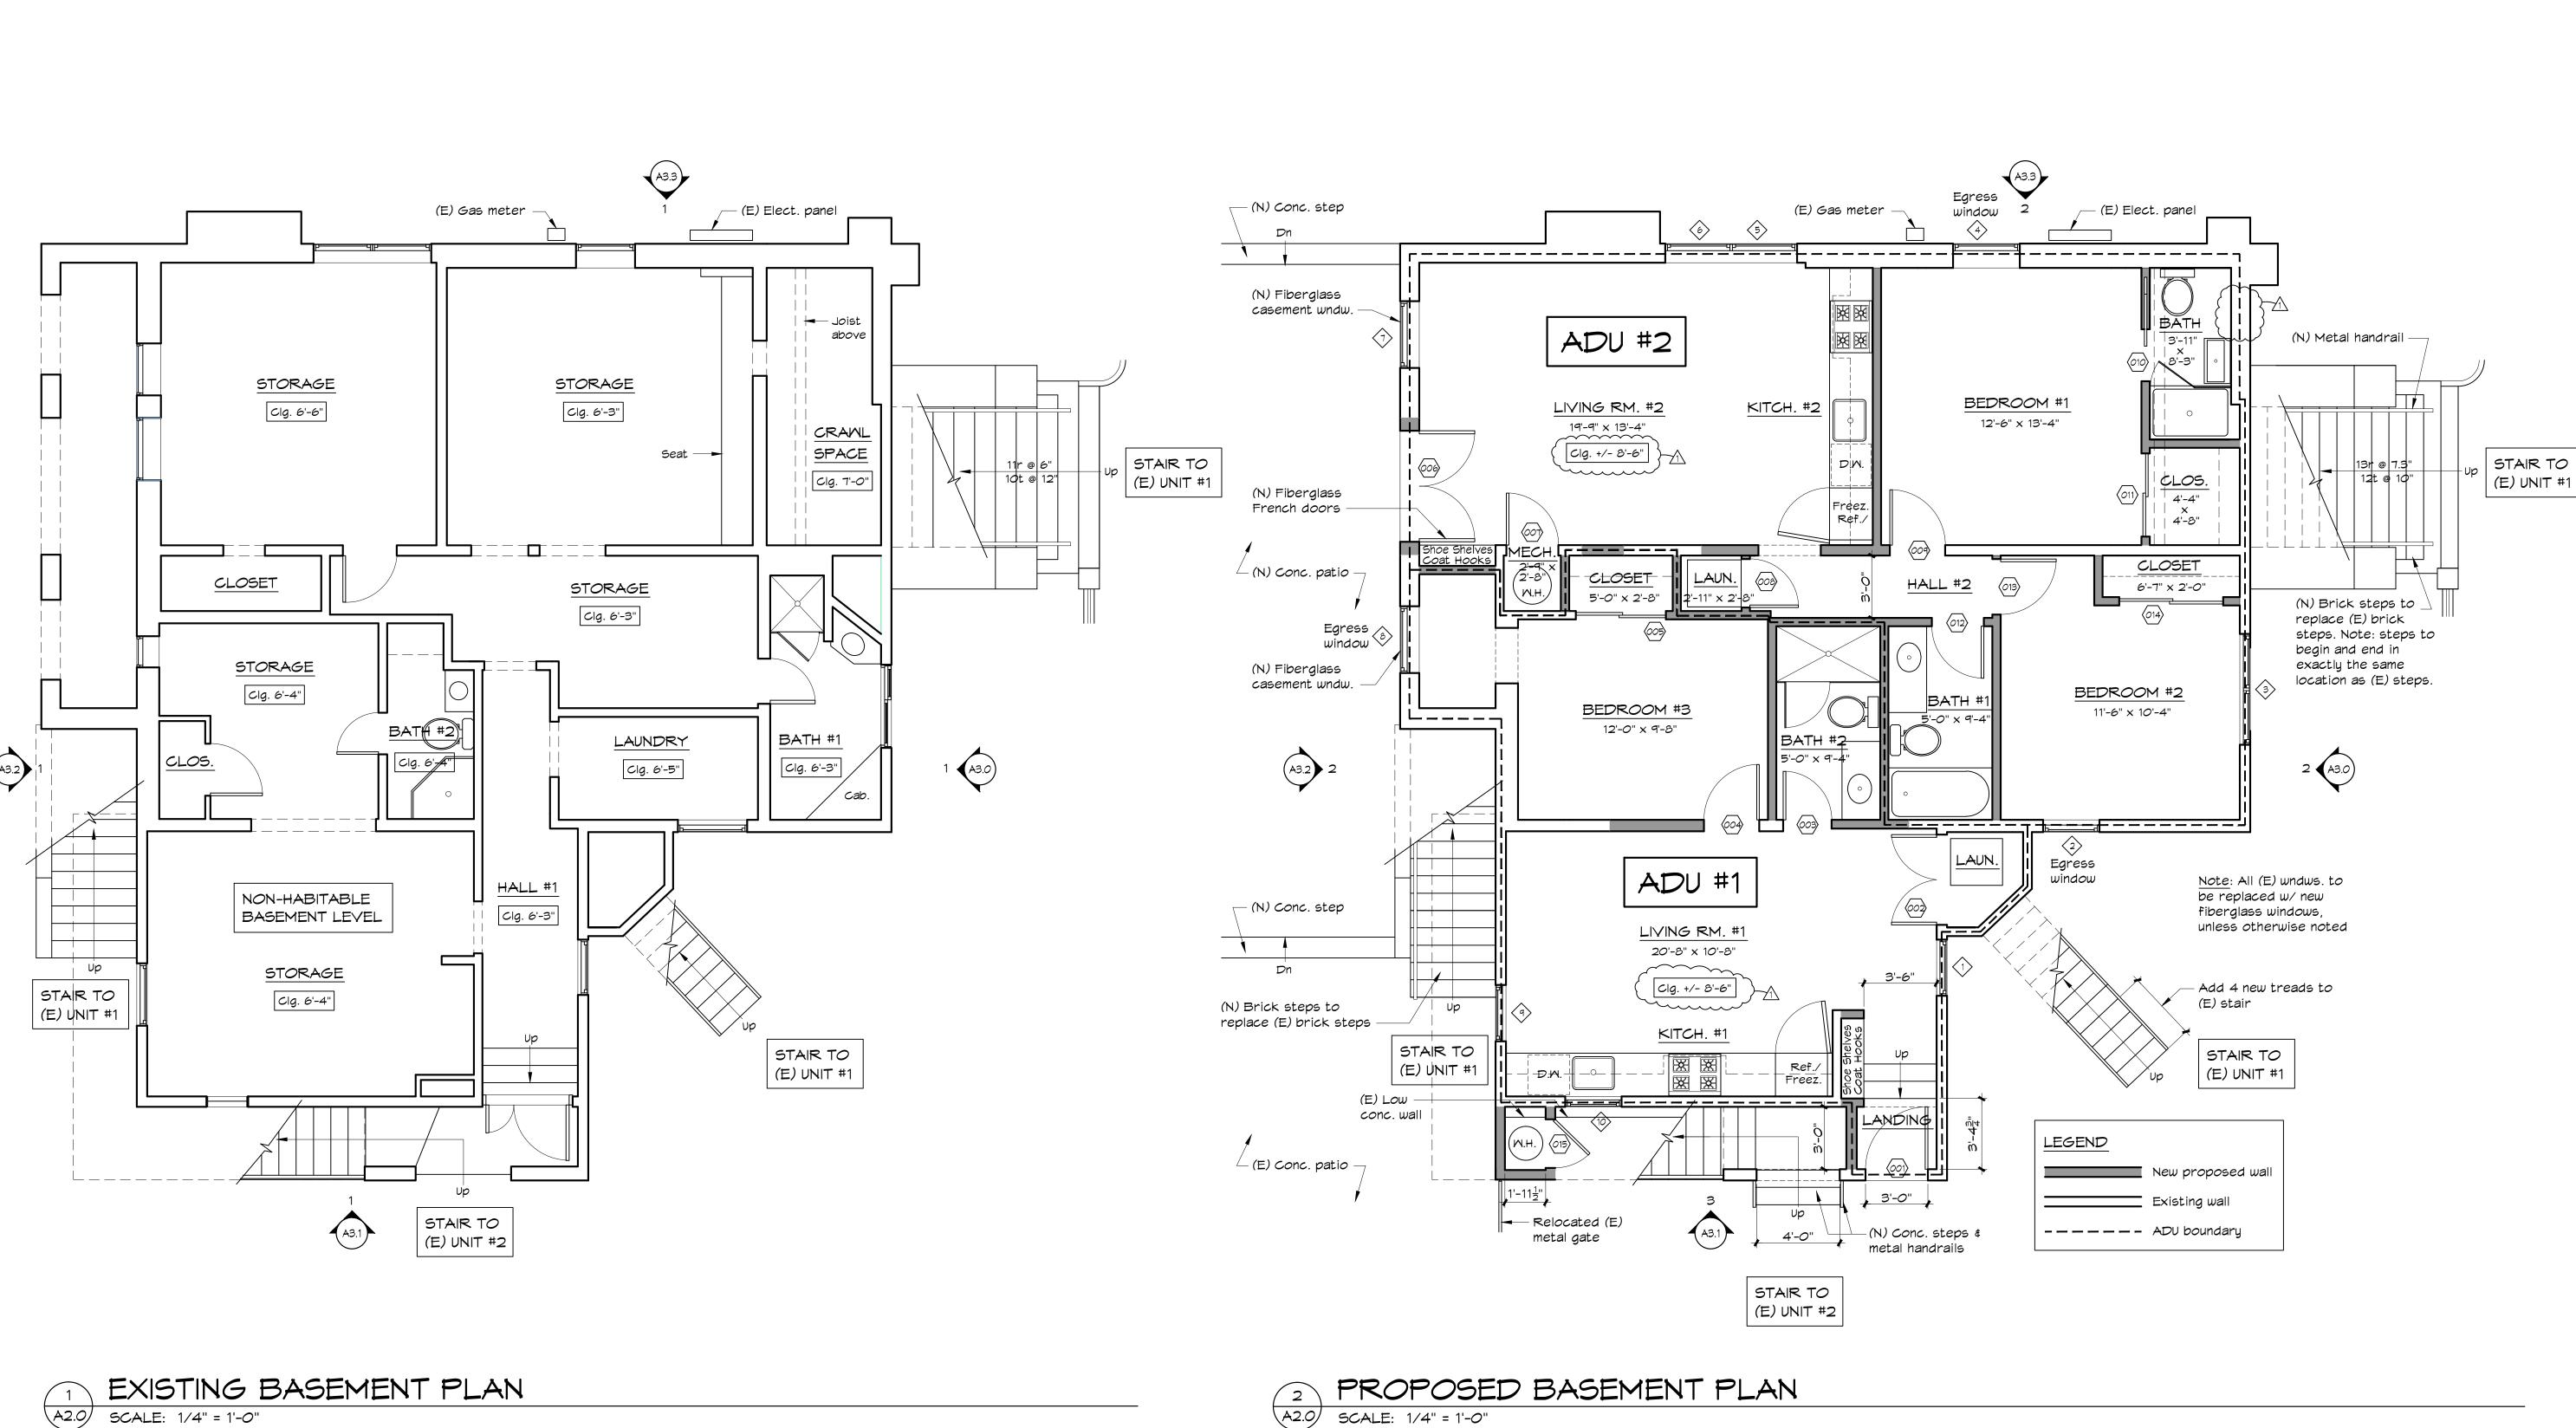



412 Shrader St., San Francisco, CA 94117 415.346.1572

1516 Oak St. #108, Alameda, CA 94502 510.697.0224



These drawings and specifications are the property of Acanthus Architecture + Design. The information on these drawings is for use solely with respect to this project and shall not be used otherwise without the written consent of Acanthus Architecture + Design.

These drawings are neither final nor are they to be used for construction until they are signed by the Architect and approved by the Building Department.

| Issued for Prelim.<br>Planning Review | 11-22-23 |
|---------------------------------------|----------|
| Issued for Planning Review            | 1-22-23  |
| •                                     |          |

Planning Review Revision#1 3-7-23


# CLINTON AVE. REMODEL

1912 Clinton Avenue Alameda, CA 94501

DRAWING TITLE

### EXIST. & PROP. BASEMENT PLAN

| SCALE     | 1/4" = 1'-0"   |
|-----------|----------------|
| DATE      | Sept. 22, 2023 |
| DRAWN BY  | DPM            |
| JOB NO.   |                |
| DRAWING N | O              |

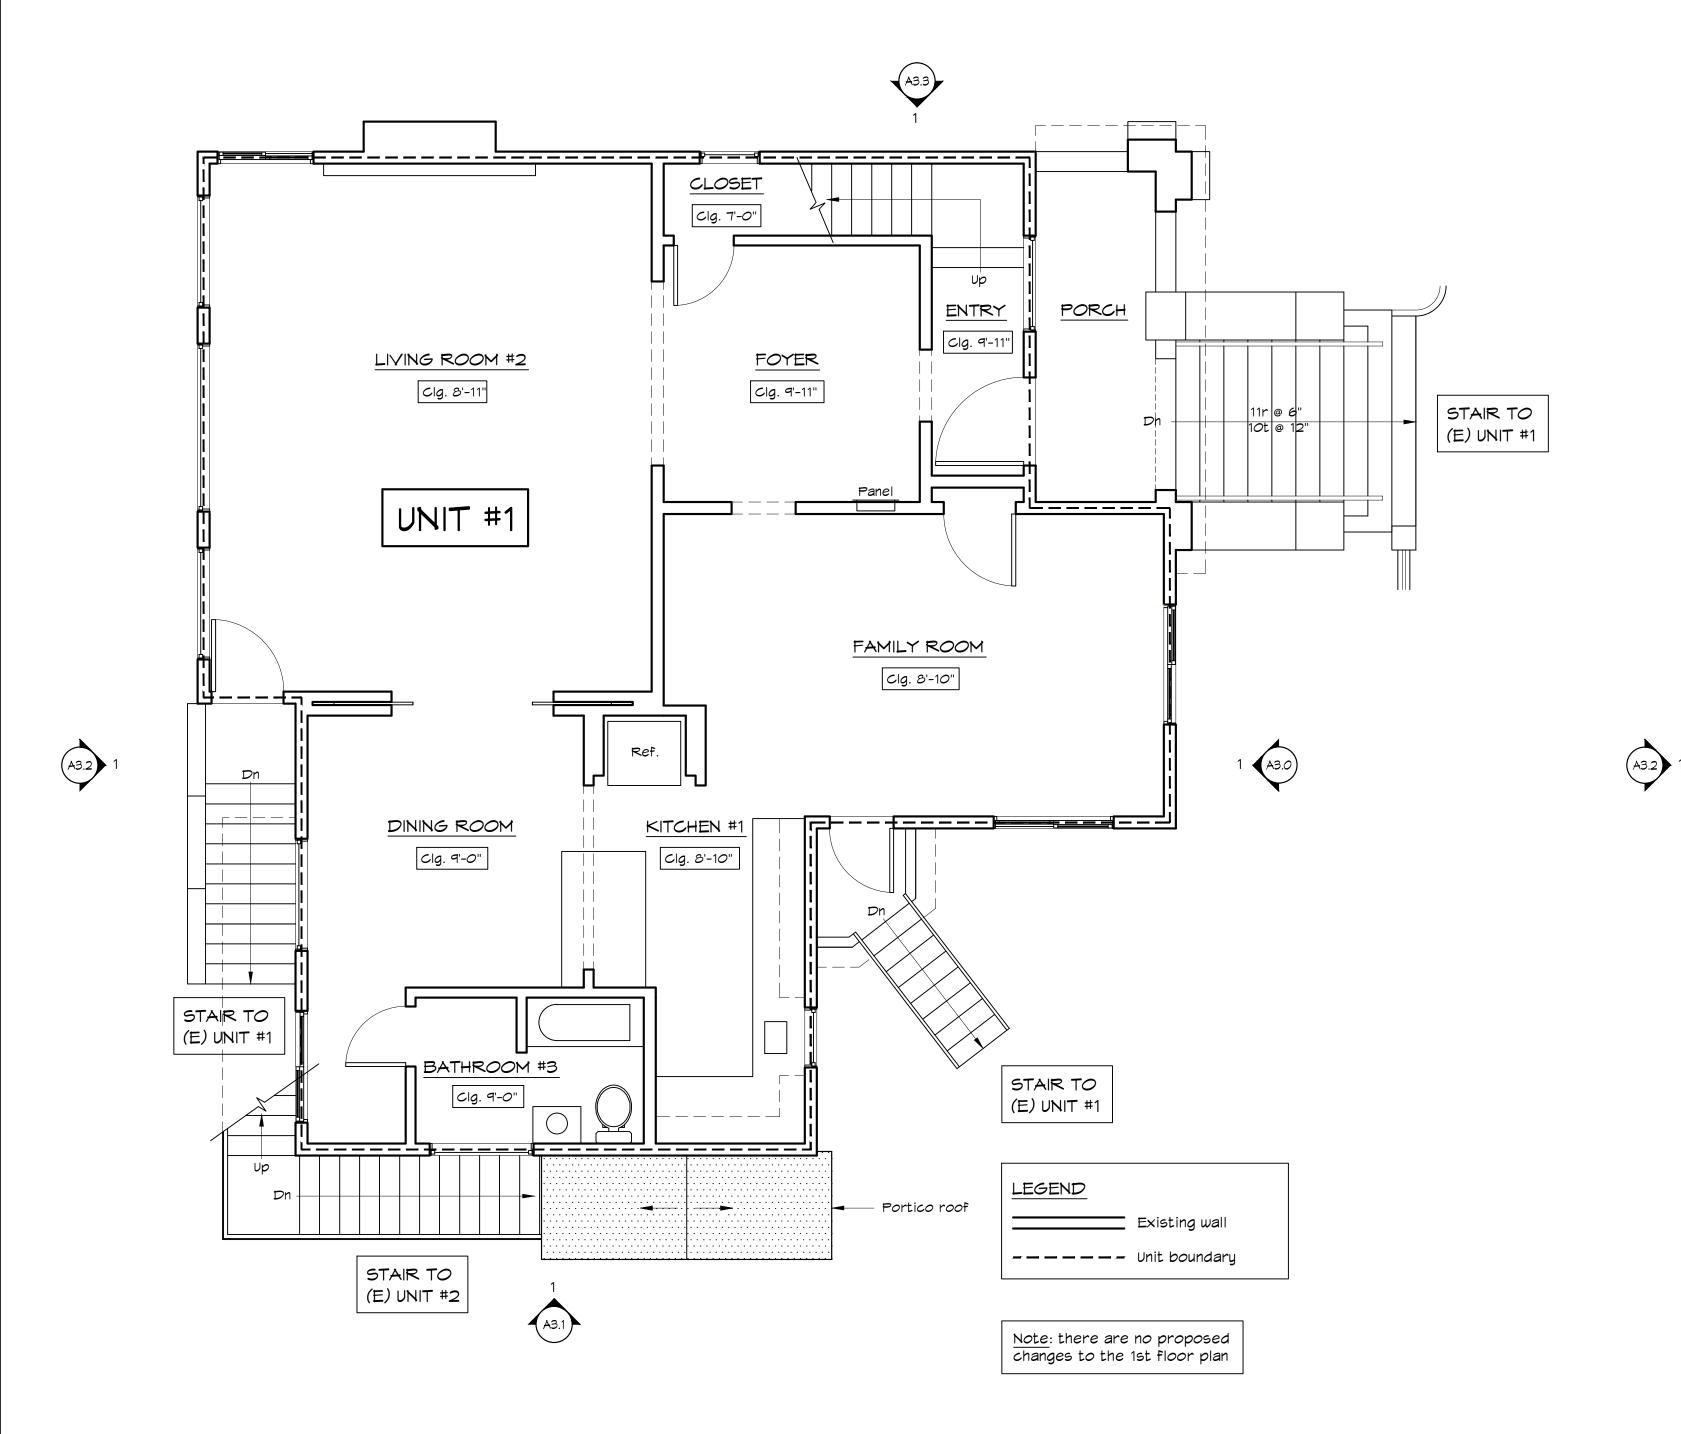

- Porch below - Porch roof BEDROOM #6 BEDROOM #5 Clg. 9'-3" Clg. 9'-3" Clg. 9'-3" CLOSET BATH #4 \_\_\_\_\_ \_\_\_\_\_\_ BEDROOM #3 BEDROOM #4 CLOS. Clg. 9'-3" Clg. 9'-3" A3.0 PORCH LIVING ROOM #3 KITCHEN #2 Clg. 9'-3" Clg. 9'-3" Porch roof UNIT #2 BATH #5 Clg. 9'-3" LEGEND Existing wall ---- Unit boundary A3.1 Note: there are no proposed changes to the 2nd floor plan

EXISTING FIRST FLOOR PLAN

A2.1) SCALE: 1/4" = 1'-0"

2 EXISTING SECOND FLOOR PLAN

SCALE: 1/4" = 1'-0"

ACANTHUS
ARCHITECTURE + DESIGN

412 Shrader St., San Francisco, CA 94117 415.346.1572

1516 Oak St. #108, Alameda, CA 94502 510.697.0224



These drawings and specifications are the property of Acanthus Architecture + Design. The information on these drawings is for use solely with respect to this project and shall not be used otherwise without the written consent of Acanthus Architecture + Design.

These drawings are neither final nor are they to be used for construction until they are signed by the Architect and approved by the Building Department.

| Issued for Prelim.<br>Planning Review | 11-22-23 |
|---------------------------------------|----------|
| Issued for Planning Review            | 1-22-23  |
| Planning Review Revision#1            | 3-7-23   |


# CLINTON AVE. REMODEL

1912 Clinton Avenue Alameda, CA 94501

DRAWING TITLE

# EXISTING FIRST & SECOND FLOOR PLANS

| SCALE     | 1/4" = 1'-0"   |
|-----------|----------------|
| DATE      | Sept. 22, 2023 |
| DRAWN BY  | DPM            |
| JOB NO.   |                |
| DRAWING N | O.             |

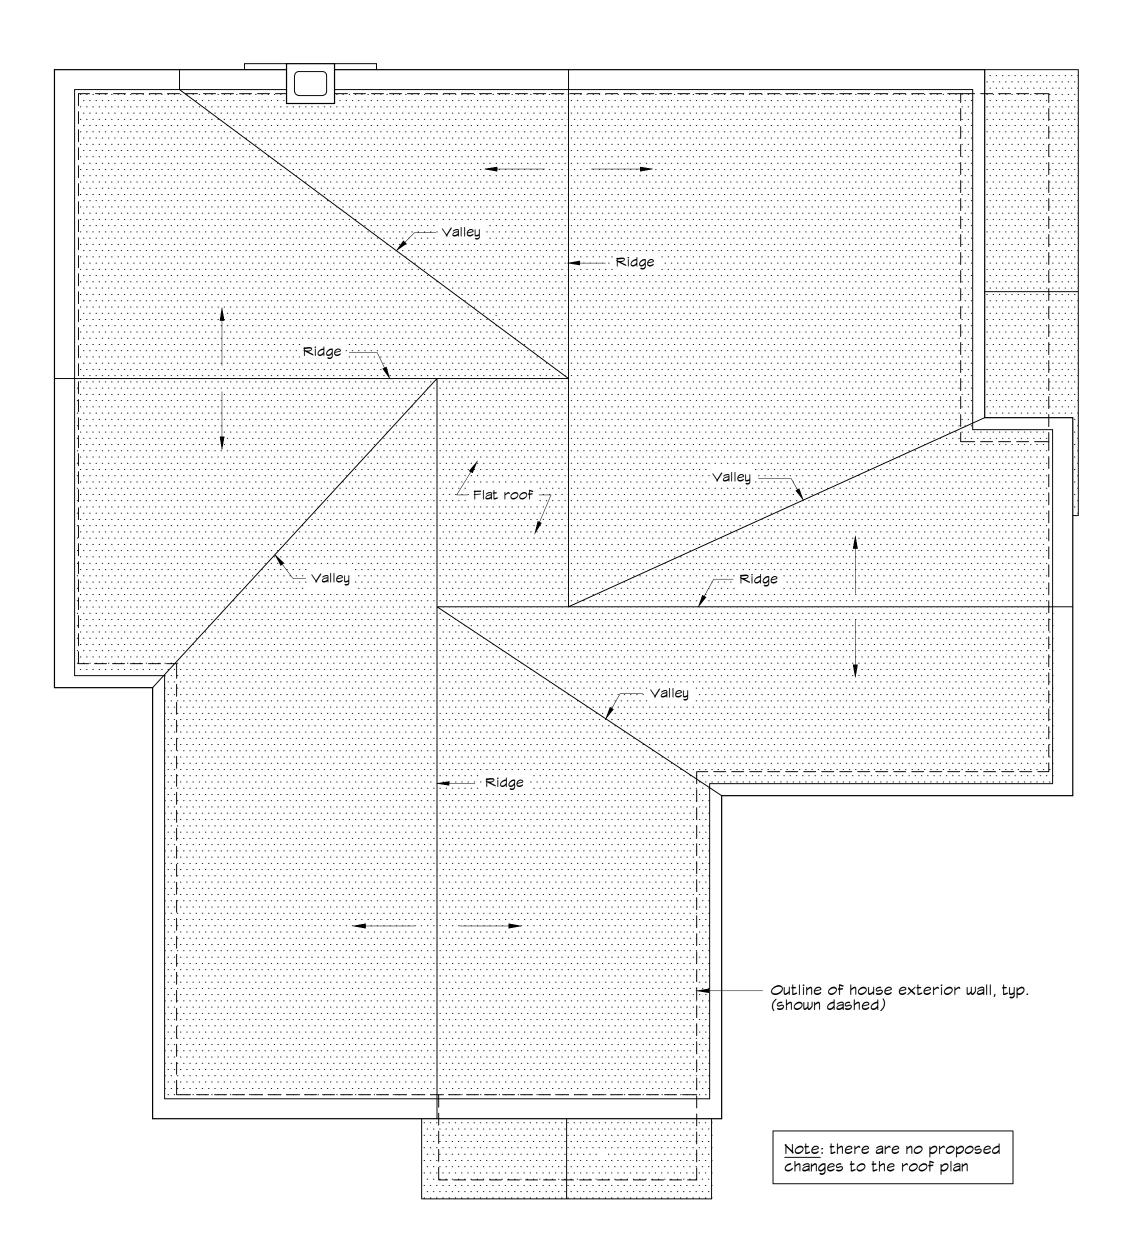

1 EXISTING ROOF PLAN
A2.2 SCALE: 1/4" = 1'-0"



412 Shrader St., San Francisco, CA 94117 415.346.1572

1516 Oak St. #108, Alameda, CA 94502 510.697.0224



These drawings and specifications are the property of Acanthus Architecture + Design. The information on these drawings is for use solely with respect to this project and shall not be used otherwise without the written consent of Acanthus Architecture + Design.

These drawings are neither final nor are they to be used for construction until they are signed by the Architect and approved by the Building Department.

| Issued for Prelim.<br>Planning Review | 11-22-2 |
|---------------------------------------|---------|
| Issued for Planning Review            | 1-22-2  |

A Planning Review Revision#1 3-7-23

# CLINTON AVE. REMODEL

1912 Clinton Avenue Alameda, CA 94501

DRAWING TITLE

existing roof plan

| SCALE    | 1/4" = 1'-0"   |
|----------|----------------|
| DATE     | Sept. 22, 2023 |
| DRAWN BY | DPM            |
| JOB NO.  |                |

#### **Window & Exterior Door Schedule**

Site Address: **1912 Clinton Ave, Alameda, CA 94501**Year Built: **"Before 1909"** (per city permit records)
Is property on City Study List or a City Monument: **No**Architectural Style of Building: **Colonial Revival** 

Note #1: All windows will be replaced with Milgard Fiberglass windows exactly/consistent with model/color/design/style of windows that currently exist on the first and second floors which were newly installed and finalled in 2023. Specifically:

installed and finalled in 2023. Specifically:

--Milgard C650 Ultra Casement windows Series 3510, 1-3/4" Z-Bar, External AND Internal colored Black Bean

--Milgard C650 Ultra Single Hung windows Series 3210, 1-3/4" Z-Bar, External AND Internal colored Black Bean --Milgard C650 Ultra In-Swing Patio doors Series 3642, 1-3/4" Z-Bar, External AND Internal colored Black Bean


2: Windows 7 & 8 and Door 006 are newly added to the New wall facing the lagoon (old wall/windows towards interior of the living room will no longer exist).

**Note #3:** Doors 001 & 006 to have tempered safety glass.

| Window # | Room                                  | Exiting<br>Window Type | New Window Type    | Existing Window<br>Material | New Window<br>Material | Existing Size (width) x (depth) | New Size<br>(width) x (depth) | MUNTINS/ GRIDS              |
|----------|---------------------------------------|------------------------|--------------------|-----------------------------|------------------------|---------------------------------|-------------------------------|-----------------------------|
| 1        | (ADU#1) Living Rm #1 - Facing Clinton | Jalousie               | Single Hung        | Aluminum / Wood             | Fiberglass             | 32" X 30"                       | 30" X 54"                     | Yes, see exterior elevation |
| 2        | (ADU#2) Bedroom #2 - Facing Chestnut  | Jalousie               | Casement - Egress  | Aluminum / Wood             | Fiberglass             | 41" X 28"                       | 30" X 54"                     | Yes, see exterior elevation |
| 3        | (ADU#2) Bedroom #2 - Facing Clinton   | Jalousie               | Single Hung (pair) | Aluminum / Wood             | Fiberglass             | 30" X 42"                       | (2) 30" X 54"                 | Yes, see exterior elevation |
| 4        | (ADU#2) Bedroom #1 - Walkway          | Jalousie               | Casement - Egress  | Aluminum / Wood             | Fiberglass             | 30" X 38"                       | 36" X 60"                     | No                          |
| 5        | (ADU#2) Living Rm #2 - Walkway (i)    | Jalousie               | Casement           | Aluminum / Wood             | Fiberglass             | 30" X 38"                       | 36" X 60"                     | No                          |
| 6        | (ADU#2) Living Rm #2 - Walkway (ii)   | Jalousie               | Casement           | Aluminum / Wood             | Fiberglass             | 30" X 38"                       | 36" X 60"                     | No                          |
| 7        | (ADU#2) Living Rm #2 - Lagoon         | -                      | Casement           | -                           | Fiberglass             | _                               | 36" X 60"                     | No                          |
| 8        | (ADU#1) Bedroom #3 - Lagoon           | -                      | Casement - Egress  | 1                           | Fiberglass             | -                               | 36" X 60"                     | No                          |
| 9        | (ADU#1) Living Rm #1 - Lagoon         | Jalousie               | Single Hung        | Aluminum / Wood             | Fiberglass             | 36" X 26"                       | 30" X 54"                     | No                          |
| 10       | (ADU#1) Kitchen #1 - Facing Chestnut  | Jalousie               | Single Hung        | Aluminum / Wood             | Fiberglass             | 25" X 24"                       | 30" X 48"                     | No                          |
| Door #   | Room                                  | Exiting Door<br>Type   | New Door Type      | Existing Door<br>Material   | New Door<br>Material   | Existing Size (width) x (depth) | New Size<br>(width) x (depth) | MUNTINS/ GRIDS              |
| 001      | (ADU#1) Entry - Facing Chestnut       | -                      | French Door        | -                           | Fiberglass             | -                               | 36"X84"                       | No                          |
| 006      | (ADU#2) Living Rm #2 - Lagoon         | -                      | French Door pair   | -                           | Fiberglass             | _                               | 66"X90"                       | No                          |


### WINDOW & EXTERIOR DOOR SCHEDULE


A2.3 SCALE: NO SCALE

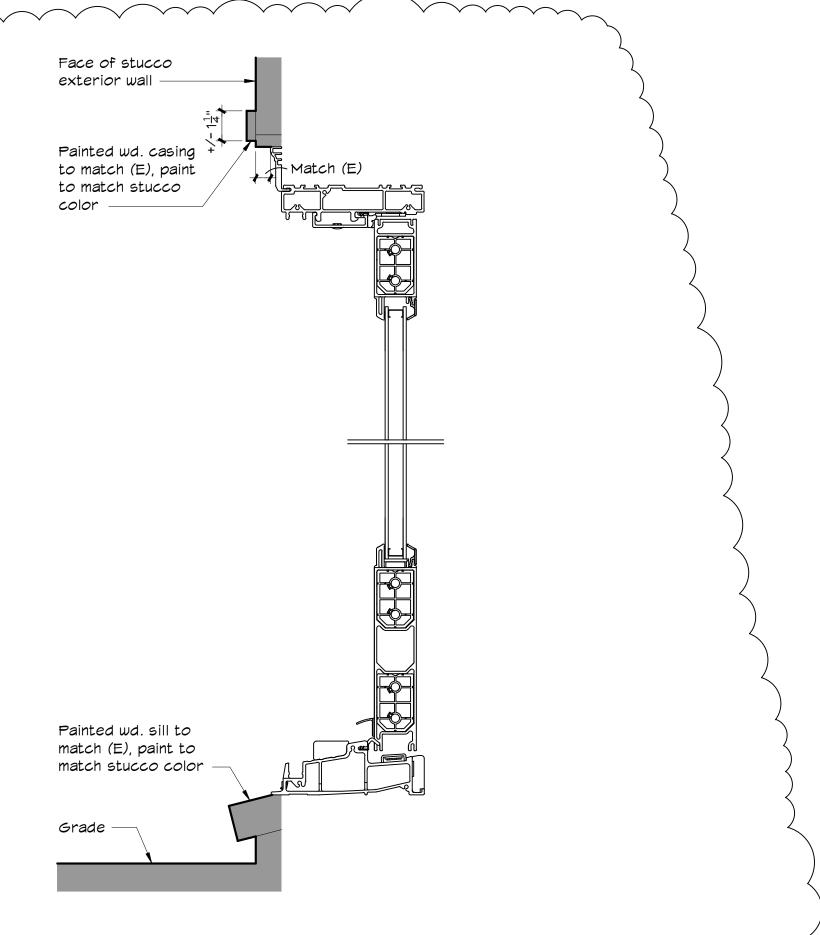

FRENCH DOOR HEAD (JAMB SIM.) & SILL DETAIL

A2.3) SCALE: 3"=1'-0"

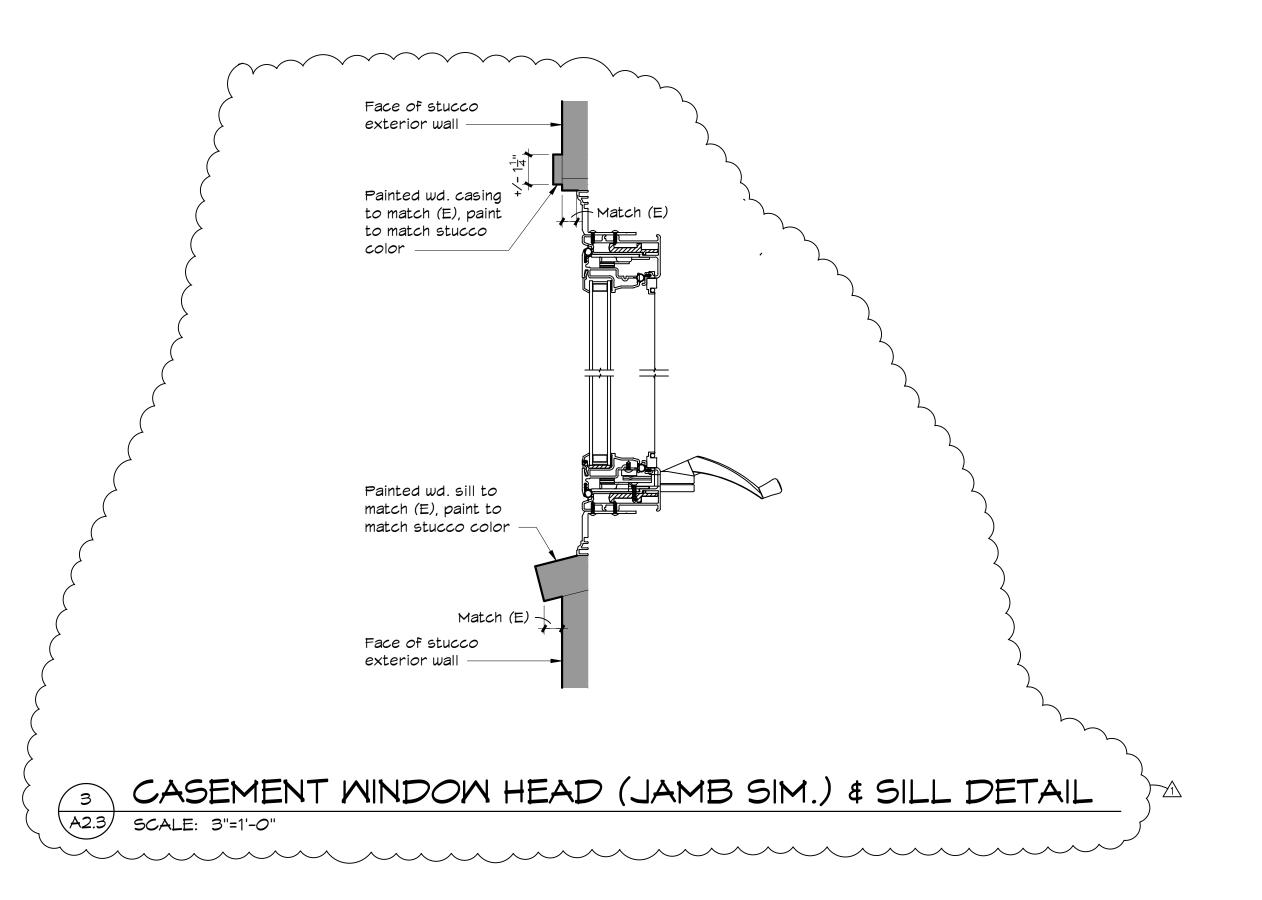

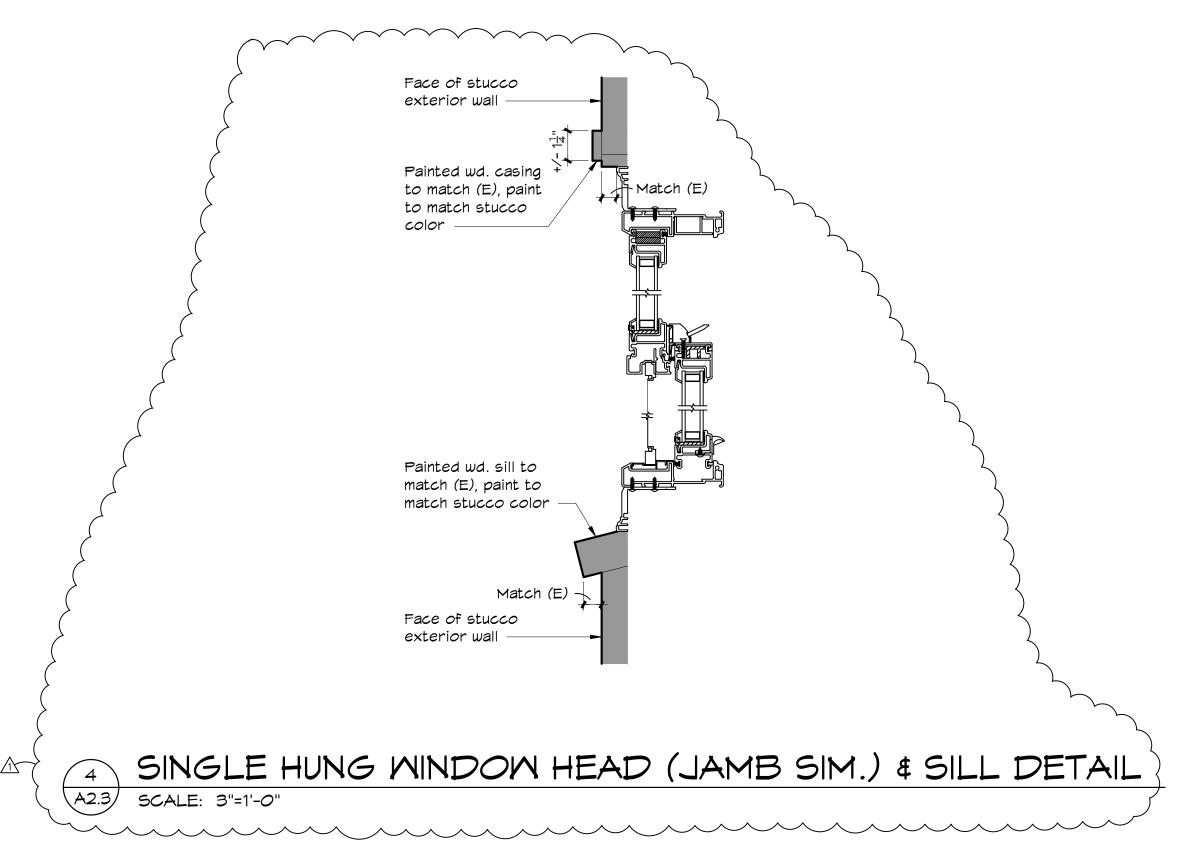

ACANTHUS
ARCHITECTURE + DESIGN

412 Shrader St., San Francisco, CA 94117 415.346.1572

1516 Oak St. #108, Alameda, CA 94502 510.697.0224



These drawings and specifications are the property of Acanthus Architecture + Design. The information on these drawings is for use solely with respect to this project and shall not be used otherwise without the written consent of Acanthus Architecture + Design.

These drawings are neither final nor are they to be used for construction until they are signed by the Architect and approved by the Building Department.

revisions dat

↑ Planning Review Revision#1 3-7-23

# CLINTON AVE. REMODEL

1912 Clinton Avenue Alameda, CA 94501

RAWING TITLE

WINDOW & DOOR SCHEDULE & DETAILS

| SCALE    | As Noted      |
|----------|---------------|
| DATE     | March 7, 2024 |
| DRAWN BY | DPM           |
| JOB NO.  |               |



### EXISTING FRONT EXTERIOR ELEVATION

A3.0 SCALE: 1/4" = 1'-0"



Note: (E) Exterior light fixtures will remain unchanged, and no new exterior light fixtures will be added.



412 Shrader St., San Francisco, CA 94117 415.346.1572

1516 Oak St. #108, Alameda, CA 94502 510.697.0224



These drawings and specifications are the property of Acanthus Architecture
+ Design. The information on these drawings is for use solely with respect to this project and shall not be used otherwise without the written consent of Acanthus Architecture + Design.

These drawings are neither final nor are they to be used for construction until they are signed by the Architect and approved by the Building Department.

| REVISIONS                             | DATE     |
|---------------------------------------|----------|
| Issued for Prelim.<br>Planning Review | 11-22-23 |
| Issued for Planning Review            | 1-22-23  |

↑ Planning Review Revision#1 3-7-23


### CLINTON AVE. REMODEL

1912 Clinton Avenue Alameda, CA 94501

DRAWING TITLE

EXIST. & PROP. **FRONT** EXTERIOR ELEVATION

| SCALE     | 1/4" = 1'-0"   |  |
|-----------|----------------|--|
| DATE      | Sept. 22, 2023 |  |
| DRAWN BY  | DPM            |  |
| JOB NO.   |                |  |
| DRAWING N | O              |  |

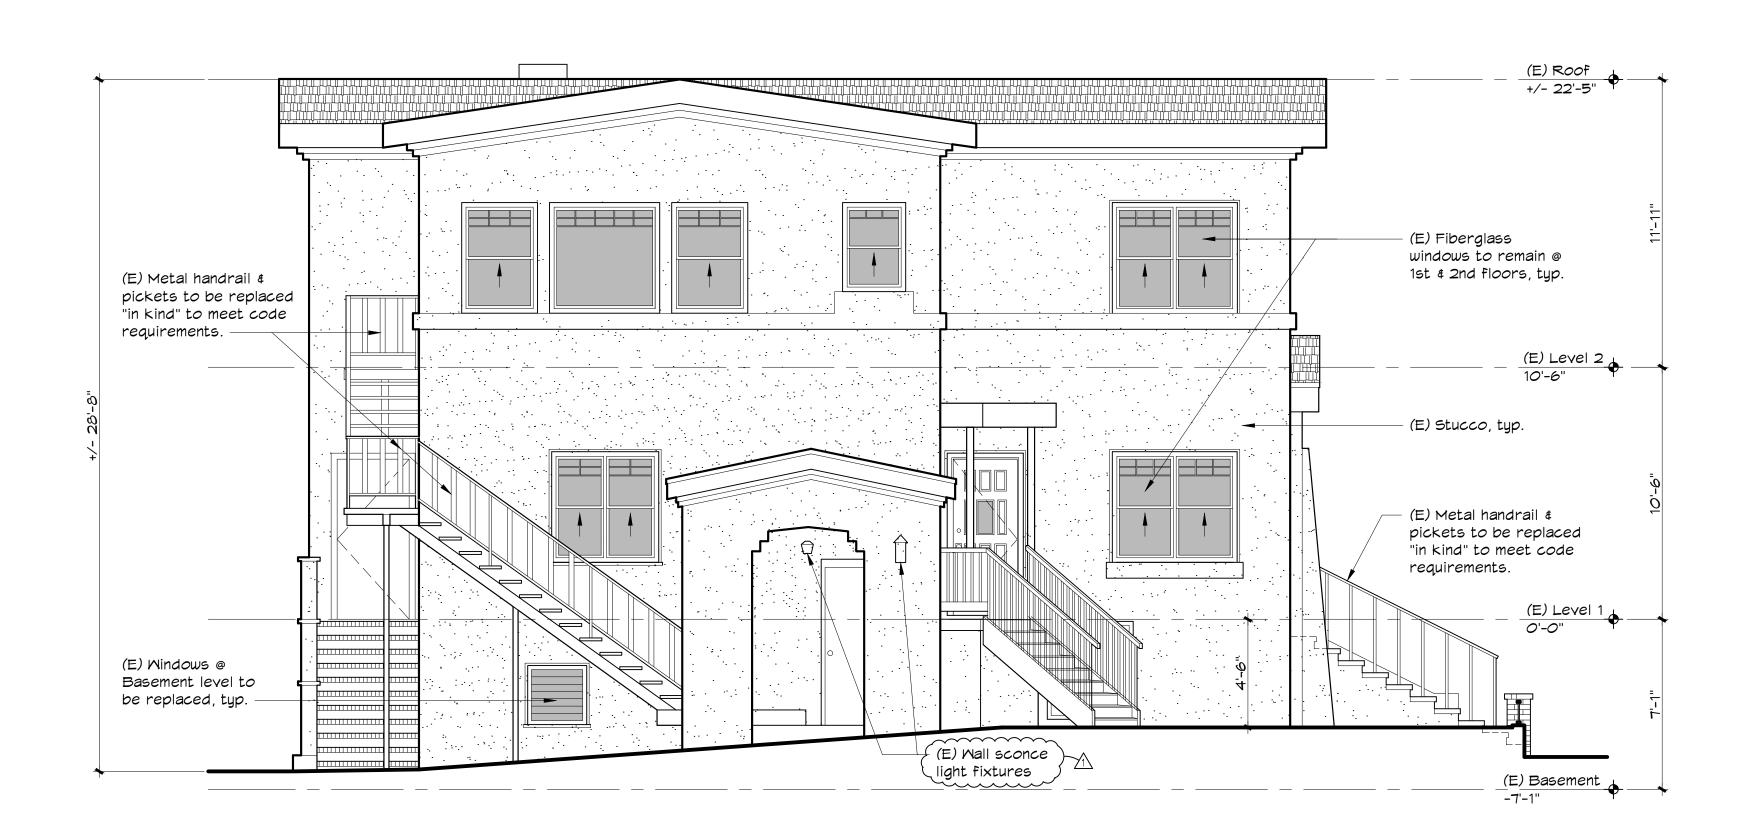

# (E) Brick piers & metal rail -

## EXISTING CHESTNUT ST. EXTERIOR ELEVATION

A3.1 SCALE: 1/4" = 1'-0"


SCALE: 1/4" = 1'-0"




PROPOSED CHESTNUT ST. EXTERIOR ELEVATION

### EXISTING BRICK PLANTER MALL @ CHESTNUT ST.

A3.1 SCALE: 1/4" = 1'-0"

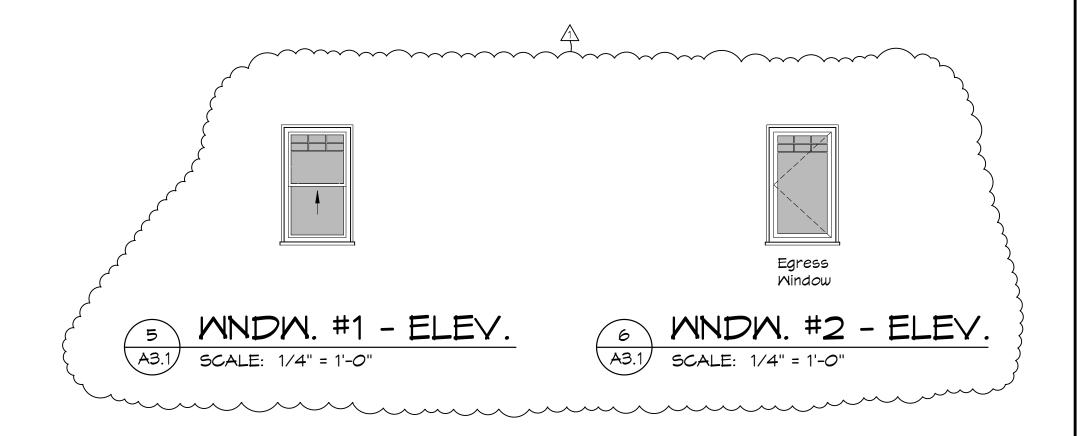

Note: (E) Exterior light fixtures will remain unchanged, and no new exterior light fixtures will be added.

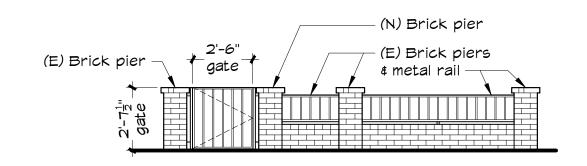

# PROPOSED GATE @ CHESTNUT ST.

A3.1) SCALE: 1/4" = 1'-0"

BRICK PLANTER MALL

Architecture + Design

412 Shrader St., San Francisco, CA 94117 415.346.1572

1516 Oak St. #108, Alameda, CA 94502 510.697.0224



These drawings and specifications are the property of Acanthus Architecture + Design. The information on these drawings is for use solely with respect to this project and shall not be used otherwise without the written consent of Acanthus Architecture + Design.

These drawings are neither final nor are they to be used for construction until they are signed by the Architect and approved by the Building Department.

Issued for Prelim. 11-22-23 Planning Review Issued for Planning Review 1-22-23


↑ Planning Review Revision#1 3-7-23

**CLINTON AVE. REMODEL** 

1912 Clinton Avenue Alameda, CA 94501


EXIST. & PROP. CHESTNUT ST. EXTERIOR ELEVATIONS

1/4" = 1'-0" Sept. 22, 2023 JOB NO.

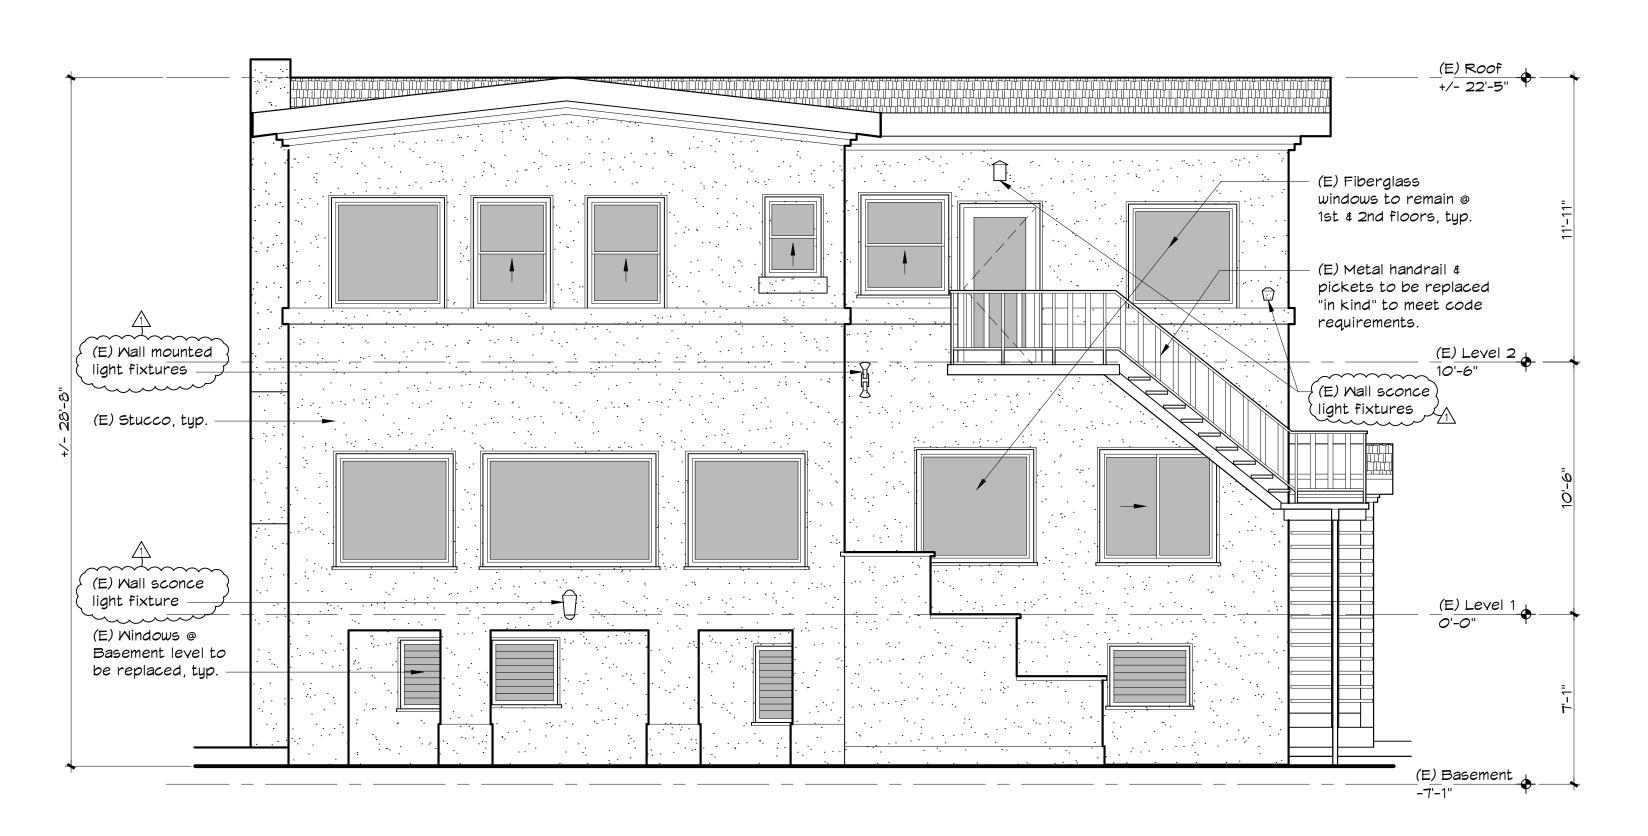

## EXISTING REAR EXTERIOR ELEVATION

A3.2 SCALE: 1/4" = 1'-0"

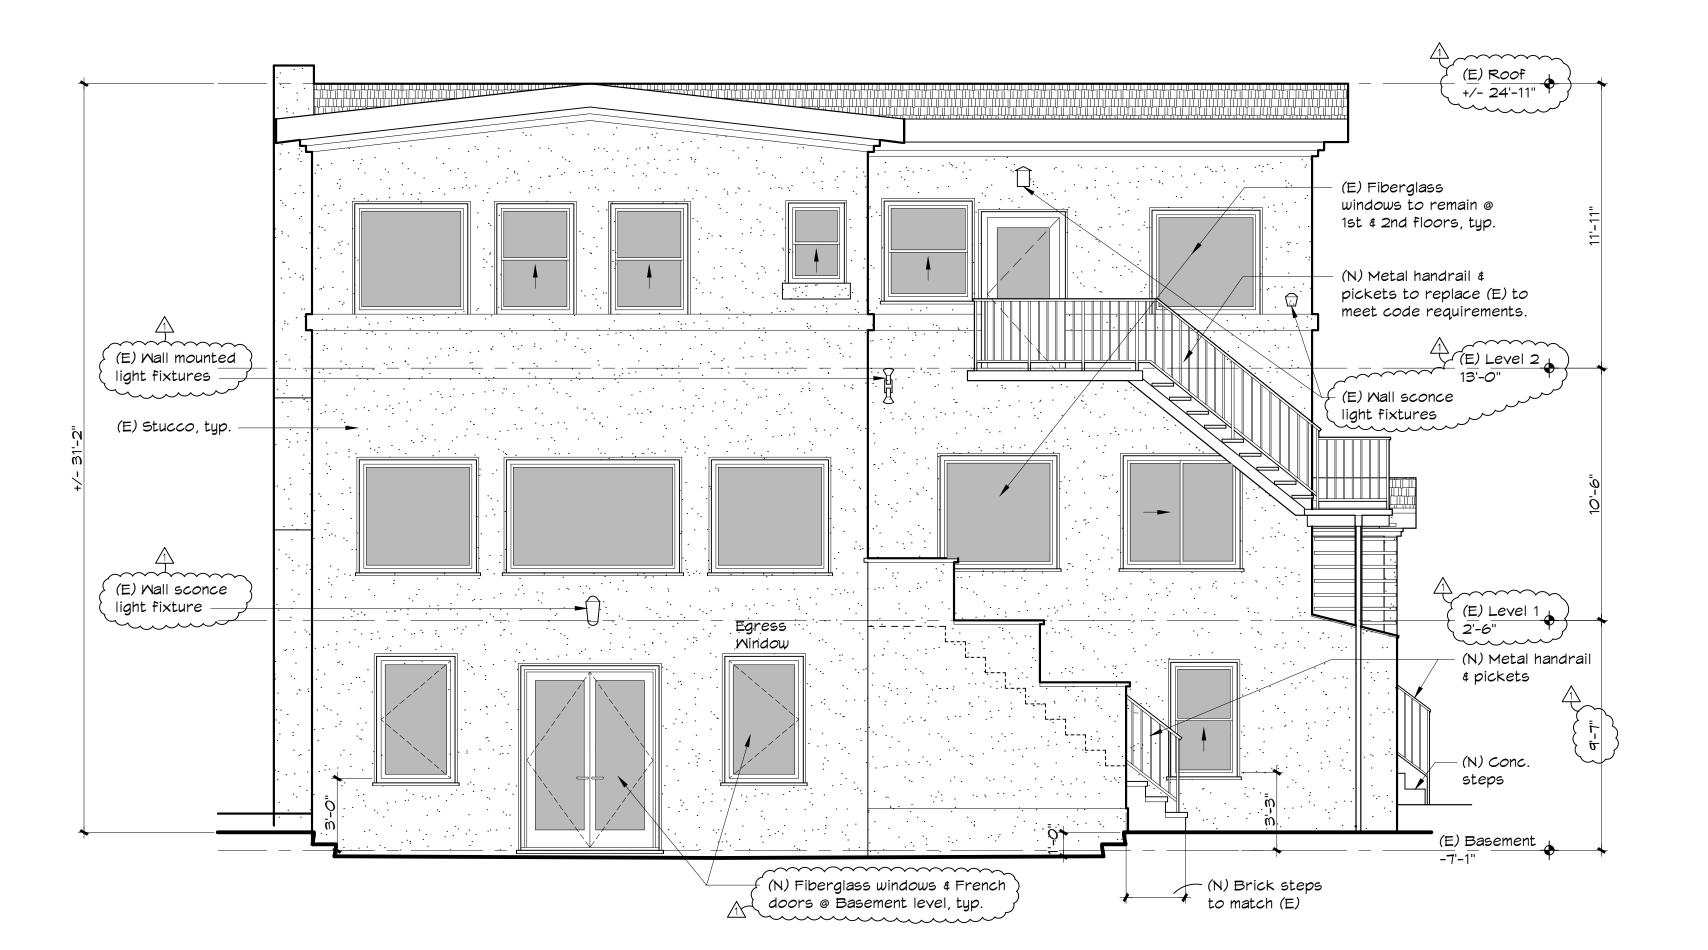

Note: (E) Exterior light fixtures will remain unchanged, and no new exterior light fixtures will be added.



412 Shrader St., San Francisco, CA 94117 415.346.1572

1516 Oak St. #108, Alameda, CA 94502 510.697.0224



These drawings and specifications are the property of Acanthus Architecture + Design. The information on these drawings is for use solely with respect to this project and shall not be used otherwise without the written consent of Acanthus Architecture + Design.

These drawings are neither final nor are they to be used for construction until they are signed by the Architect and approved by the Building Department.

| KEVISIONS                             | DAIE     |
|---------------------------------------|----------|
| Issued for Prelim.<br>Planning Review | 11-22-23 |
| Issued for Planning Review            | 1-22-23  |

↑ Planning Review Revision#1 3-7-23


### **CLINTON AVE.** REMODEL

1912 Clinton Avenue Alameda, CA 94501

DRAWING TITLE

### EXIST. & PROP. REAR EXTERIOR ELEVATIONS

| SCALE     | 1/4" = 1'-0"   |  |
|-----------|----------------|--|
| DATE      | Sept. 22, 2023 |  |
| DRAWN BY  | DPM            |  |
| JOB NO.   |                |  |
| DRAWING N | O              |  |

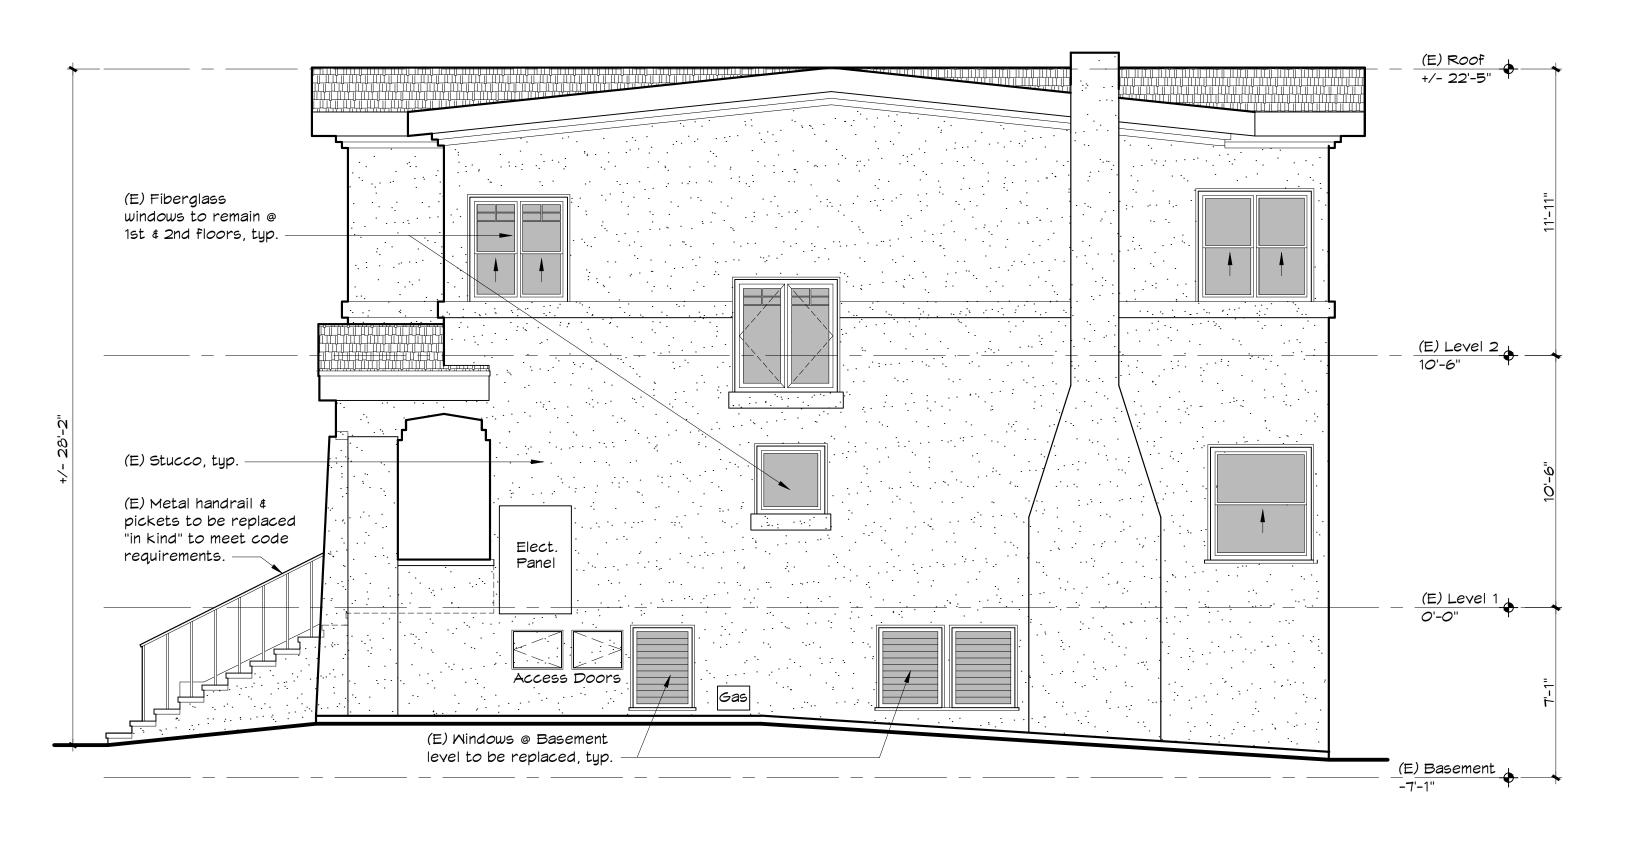

### EXISTING DRIVENAY EXTERIOR ELEVATION 1 EXISTING I A3.3 SCALE: 1/4" = 1'-0"



Note: (E) Exterior light fixtures will remain unchanged, and no new exterior light fixtures will be added.

ARCHITECTURE + DESIGN

412 Shrader St., San Francisco, CA 94117 415.346.1572

1516 Oak St. #108, Alameda, CA 94502 510.697.0224



These drawings and specifications are the property of Acanthus Architecture + Design. The information on these drawings is for use solely with respect to this project and shall not be used otherwise without the written consent of Acanthus Architecture + Design.

These drawings are neither final nor are they to be used for construction until they are signed by the Architect and approved by the Building Department.

| KEAI2ION2                             | DAIL      |
|---------------------------------------|-----------|
| Issued for Prelim.<br>Planning Review | 11-22-23  |
| Issued for Planning Review            | v 1-22-23 |

↑ Planning Review Revision#1 3-7-23

### **CLINTON AVE.** REMODEL

1912 Clinton Avenue Alameda, CA 94501

### EXIST. & PROP. DRIVEWAY EXTERIOR ELEVATIONS

| SCALE     | 1/4" = 1'-0"   |
|-----------|----------------|
| DATE      | Sept. 22, 2023 |
| DRAWN BY  | DPM            |
| JOB NO.   |                |
| DRAWING N | O.             |