

**ABBREVIATIONS** PROP PSI CONDITIONING PHALT CONCRETE PAVING POUNDS PER
SQUARE INCH
POINT/PRESSURE TREATED
PAPER TOWEL DISPENSER
& RECEPTACLE
POLYVINYL CHLORIDE ELUOR PT PTD/R REMODELED/RENOVATED , ₹ĒPLĂCE RISER/RADIUS ROOF DRAIN REFERENCE/REFRIGERATOR REFRIGERATOR ENERAL CONTRACTOR GALVANIZED IRON TÜMINOUS GENERAL SERV. AGENCY GYPSUM WALL BOARD JILDING OCKING RAIN WATER LEADER HOT & COLD SUPPLY SOLID CORE SEAT COVER DISPENSER CALIPER COLD AIR RETURN HARDWARE HORIZONTAL
HORIZONTAL
HIGH POINT
HOUR
HEIGHT
HEATER
HEATING, VENTILATION AND
AIR CONDITIONING SOLID CORE METAL SOLID CORE WOOD SCM SCWD TORM DRAIN LECTRICAL DRAWINGS CAST IRON
CONSTRUCTION JOINT
CENTER LINE
CHAIN LINK FENCE SMOOTH FOUR SIDES SEMI-GLOSS (PAINT) SHEET SINGLE HUNG SLIDING (WINDOW OR DOOR) CLEAR
CONCRETE MASONRY UNIT
CHAIN LINK
COUNTER
CLEANOUT
COLUMN
COMPOSITION
CONCRETE
CONDITION
CONNECTION
CONSTRUCTION
CONTINUOUS
CORRIDOR
COLUMN
COLUMN
CONTINUOUS
CORRIDOR
COLUMN
COLUMN
COLUMN
CONTINUOUS
COLUMN
C SEE LANDSCAPE DRAWINGS SEE MECHANICAL DRAWINGS SUMP PUMP SANITARY NAPKIN DISPENSER SANITARY NAPKIN RECEPTACLE SUB PANEL (ELECTRIC) SPECIFICATION JANITOR JOINT(S) KILN DRIED STAINLESS STEEL SERVICE SINK LANDSCAPE ARCHITECT LAMINATE LAVATORY SEE STRUCTURAL DRAWINGS STANDARD CLASSROOM CASEMENT (WINDOW) CERAMIC TILE CENTER LANDSCAPE CONTRACTOR LINEAL FEET ČTR CTSK CY LIGHT LINOLEUM SHEET LOW POINT LIGHTING COUNTERSUNK CUBIC YARD TREAD
TEMPERED GLASS
TOP AND BOTTOM
TONGUE AND GROOVE
TOWEL BAR
TO BE DETERMINED DEMO DOUBLE DEDICATED DEPARTMENT DETAIL
DRINKING F
DOUBLE HU
DIAMETER
DIMENSION
DISPOSAL MECHANICAL MEMBRANE TRENCH DRAIN
TELEPHONE
TEMPORARY METAL MANUFACTURER MASONRY MOISTURE MOTION S MOUNT DRAWING DOMESTIC WATER SUPPLY ET PAPER DISPENSER OF RAIL P OF WALL TYPICAL TO MATCH EXISTING TANKLESS WATER HEATER

UBC UCG UMC UNF UNO UNS UPC URSB UWP

VŴΟ

WSP WT

NUMBER

ON CENTER OUTSIDE DIAMETER

POLE & SHELF PARTITION PRECAST CONCRETE PERFORATED

PAINTED
POINT OF CONNECTION
PATH OF TRAVEL

UNIFORM MECHANICAL CODE

UNLESS NOTED OTHERWISE UNDERSIDE OF STRUCTURE

UNIFORM PLUMBING CODE

URINAL USB PORT UPPER WORKING POINT

VINYL VINYL COMPOSITION TILE VERTICAL VESTIBULE

VERIFY WITH OWNER

WALL HEATER WATER METER

WET STAND PIPE WEIGHT WELDED WIRE FABRIC

# **GENERAL NOTES**

. ALL WORK SHALL BE PERFORMED TO THE FOLLOWING CODES:

a.	CALIFORNIA	BUILDING CODE	2022	EDITIC
b.	CALIFORNIA	MECHANICAL CODE	2022	<b>EDITIC</b>
c.	CALIFORNIA	PLUMBING CODE	2022	EDITIC
d.	CALIFORNIA	ELECTRICAL CODE	2022	<b>EDITIC</b>
e.	CALIFORNIA	ENERGY CODE	2022	<b>EDITIC</b>
f.	CALIFORNIA	FIRE CODE	2022	<b>EDITIC</b>
g.	CALIFORNIA	GREEN BUILDING STANDARDS CODE	2022	<b>EDITIC</b>
ĥ.	CALIFORNIA	HISTORIC BUILDING CODE	2022	<b>EDITIC</b>
:		DECIDENTIAL CODE	2022	CDITIC

- . CALIFORNIA RESIDENTIAL CODE CALIFORNIA EXISTING BUILDING CODE 2019 EDITION k. CITY OF ALAMEDA MUNICIPAL CODE 2019 EDITION OR CURRENT EDITION
- 3. IT SHALL BE THE RESPONSIBILITY OF THE CONTRACTOR TO NOTIFY THE ARCHITECT OF ANY DISCREPANCIES OR CONFLICTS IN THE DESIGN DWGS.

2. CONTRACTOR SHALL ADHERE TO ALL CODES, RULES & REGULATIONS GOVERNING CONSTRUCTION,


BUILDING ACCESS & THE USE OF FACILITIES AS SET BY FEDERAL, STATE & LOCAL BUILDING CODES.

- 4. ASSUMPTIONS HAVE BEEN MADE REGARDING THE (E) STRUCTURE & CONDITIONS OF WALLS, FLOORS, CEILING & BUILDING COMPONENTS. CONTRACTOR SHALL VERIFY (E) CONDITIONS AS BUILDING STRUCTURE IS UNCOVERED. CONTRACTOR SHALL NOTIFY OWNER IMMEDIATELY OF CONDITIONS DIFFERENT FROM DWGS. ARCHITECT DOES NOT ASSUME RESPONSIBILITY FOR (E) STRUCTURE OR ITS LOCATION & CONDITION.
- 5. CONTRACTOR SHALL BE RESPONSIBLE FOR PROVIDING ALL MATERIALS & WORKMANSHIP (U.N.O.) IN ACCORDANCE WITH ALL FEDERAL. STATE & LOCAL CODES
- 3. THE CONTRACTOR SHALL VERIFY ALL DIMS & (E) CONDITIONS IN THE FIELD & NOTIFY ARCHITECT, IN WRITING, OF ANY DISCREPANCIES PRIOR TO START OF WORK
- 7. LARGE SCALE DWGS TAKE PRESEDENCE OVER SMALL SCALE DWGS.
- 8. ALL DIMS SHOWN ARE TO FACE OF FINISHED WALLS U.N.O.
- 9. SEE STRUCTURAL DWGS FOR FOUNDATION, SLAB & ALL OTHER STRUCTURAL INFORMATION & DETAILS.
- 10. NOTIFY THE OWNER & ARCHITECT IF MODIFICATIONS TO STRUCTURAL COMPONENTS ARE REQUIRED TO COMPLETE THE WORK & ARE NOT DESCRIBED IN THE CONTRACT DOCUMENTS.
- 11. THESE DWGS SHALL NOT BE SCALED.
- 12. PROVIDE NATURAL LIGHT (8% MIN. OF ROOM AREA) & NATURAL VENTILATION (5% MIN OF ROOM AREA) OR MECHANICAL VENTILATION PER CODE.
- 13. PROVIDE ESCAPE/EGRESS WINDOWS IN BEDROOMS. MIN. NET CLEAR OPENING: H=24" OR W=20" & AREA=5.7 SQ.FT. MAX 44" AFF TO CLR OPNG. OR PROVIDE DOORWAY DIRECTLY TO EXTERIOR.
- 14. CONTRACTOR IS RESPONSIBLE FOR THE DESIGN & CONSTRUCTION OF ANY TEMPORARY SHORING &/OR BRACING FOR ANY CONSTRUCTION.
- 15. REVIEW ALL EXISTING INTERIOR AND EXTERIOR CONDITIONS INCLUDING EXTERIOR SIDING, TRIM, FASCIAS, STRUCTURAL ELEMENTS, PLUMBING, ELECTRICAL, ETC. IT IS THE CONTRACTOR'S RESPONSIBILITY TO FIELD INSPECT ALL SURFACES AND CONSTRUCTION COMPONENTS PRIOR TO SUBMITTING BIDDING DOCUMENTATION. IF CONDITIONS ARE FOUND WHERE REPLACEMENT OF COMPONENTS OR FINISHES ARE REQUIRED THAT ARE NOT INDICATED IN THE DRAWINGS OR SPECIFICATIONS THEN A LINE ITEM IN THE BIDDING DOCUMENTS MUST BE PROVIDED INDICATING THE EXTENT OF WORK, COST OF THE MATERIALS, FABRICATION, INSTALLATION, ETC. & TIME REQUIRED TO EXECUTE THE LINE ITEM(S)
- 16. IT IS THE OWNER'S & GENERAL CONTRACTOR'S RESPONSIBILITY TO DISTRIBUTE THE ASSOCIATED SPECIFICATION BOOK FOR THIS PROJECT TO ALL SUBCONTRACTORS FOR REVIEW PRIOR TO BIDDING & CONSTRUCTION. THE SPECIFICATIONS ARE INTERGRAL TO THE PROJECT AND ARE A LEGAL & BINDING DOCUMENT PERTAINING TO THE PROJECT.
- 17. SMOKE & CARBON MONOXIDE DETECTORS SHALL BE FIELD VERIFIED OR INSTALLED IN ACCORDANCE W/CODE.
- 18. TITLE 24 ENERGY COMPLIANCE MAY REQUIRE "HERS" AND/OR "QII" TESTING BEFORE, DURING AND/OR AFTER CONSTRUCTION. CAREFULLY REVIEW THE ENCLOSED TITLE 24 DOCUMENTATION FOR THESE REQUIREMENTS. GENERAL CONTRACTOR IS RESPONSIBLE FOR RESPONDING TO THE REQUIREMENTS & COORDINATING & CALLING FOR THESE INSPECTIONS.

### **DEMO NOTES**

- DEMOLITION IS NOT LIMITED TO WHAT IS SHOWN. DWGS INDICATE GENERAL INTENT OF DEMOLITION AREAS ONLY. PLAN INDICATES THE GENERAL SCOPE OF DEMOLITION TO COMPLETE THE PROJECT AS SHOWN ON THE CONSTRUCTION PLAN.
- 2. CONTRACTOR TO VERIFY LOCATION OF (E) UTILITIES & SAFEGUARD PRIOR TO STARTING DEMO. IT IS THE CONTRACTOR'S RESPONSIBILITY TO LOCATE, CAP, RECONNECT, RELOCATE OR REMOVE ANY &/OR ALL UTILITIES BEFORE, DURING & AFTER DEMO & (N) CONSTRUCTION.
- 3. THE CONTRACTOR SHALL COORDINATE WITH BUILDING OWNER THE REMOVAL OF DEBRIS.
- 4. WHERE (E) CONSTRUCTION IS REMOVED, ALL FIXTURES (OUTLETS, SWITCHES, THERMOSTATS, ETC.) SHALL ALSO BE REMOVED & CAPPED BEHIND FINISHED WALL UNLESS FIXTURES ARE TO BE REUSED &/OR RELOCATED. CONCEAL NO SWITCHES, JCT. BOXES, ETC. IN WALLS.
- 5. WHERE (E) CONSTRUCTION IS DISTURBED BY DEMOLITON OR NEW WORK, IT SHALL BE REPAIRED &/OR PATCHED TO MATCH (E) FINISH OR AS SPECIFIED IN THE DWGS.
- 6. PATCH & REPAIR ROOF WHERE NEW CONSTRUCTION OCCURS. MATCH (E) MATERIALS & SYSTEMS.
- 7. ALL WASTE MANAGEMENT DOCUMENTATION IS TO BE PERFORMED ON THE "GREENHALO" REPORTING WEBSITE. MIN 65% MIN RECYCLING RATE PER CALGREEN CODE.

## **PROJECT AREA**

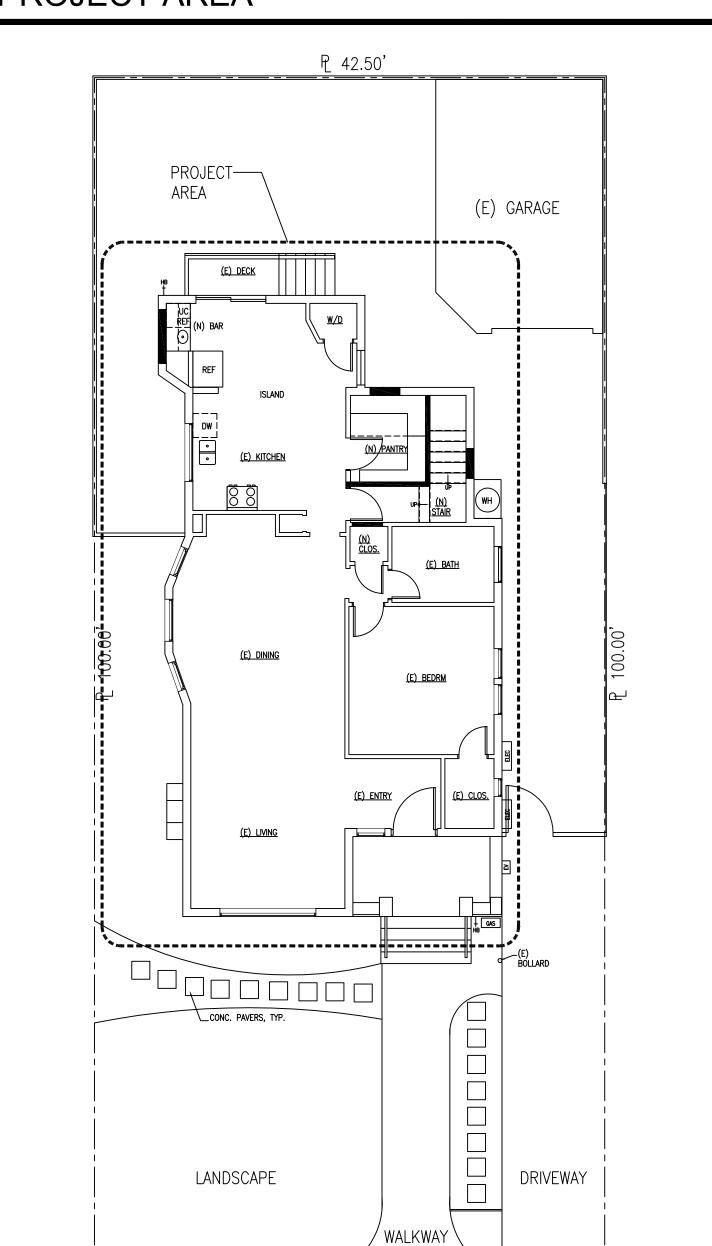

, PROJECT AREA

J 1/8"=1'-0"



### **CONTACT INFO**

ASHLEY AULD-FISHER & ANDY FISHER 337 SANTA CLARA AVENUE ALAMEDA, CA 94501

PROJECT DESCRIPTION AND USE

REPLACE FOUNDATION.

ADD UPPER FLOOR.

PARCEL NUMBER:

**CONSTRUCTION TYPE:** 

ZONING

OCCUPANCY:

(415) 259-7314

**STRUCTURAL ENGINEER:** LOU XIAO, S.E. 723 CAMINO PLAZA #115 SAN BRUNO, CA 94066 (415) 601-9686

P 510-520-6528 E : DanielHoyArch@gmail.com

ALAMEDA, CALIFORNIA 94501

DANIEL HOY, AIA ARCHITECTURE 314 PACIFIC AVENUE

BE USED FOR OTHER WORK WITHOUT THE WRITTEN

NUE 9450

0

A Z

OR

MED,

3

# CONSENT OF THE ARCHITECT

NTIAL

SIDE NOV

Checked By

### DEFERRED SUBMITTALS 1. PLUMBING LINE DIAGRAMS

SUBMITTAL LIST APPD BY ERIC SHIMP, CBO:

2. GREEN HALO REGISTRATION (BY SELECTED CONTRACTOR)

SITE DATA & CALCULATIONS

RENOVATION OF EXISTING SINGLE FAMILY RESIDENCE.

RELOCATE & ADD NEW BEARING WALLS, NON-BEARING WALLS, PLUMBING

ADD ONE NEW BEDROOM, FAMILY (GAME) ROOM AND BATHROOM UPSTAIRS.

TYPE VB, NON-RATED, NON-SPRINKLERED

5. INSTALL NEW WINDOWS WITH LIKE IN-KIND. INSTALL NEW INTERIOR DOORS

74-465-4

R-1

SUBMITTAL LIST APPD BY DPW:

<u>CITY OF ALAMEDA LOT SUMMARY TABLE</u> ZONING COMPLIANCE FOR RESIDENTIAL DISTRICT: R-1									
CATEGORIES	STANDARD	EXISTING	PROPOSED						
TOTAL LOT AREA	5,000 SF	4,250 SF	4,250 SF						
LOT DEPTH	100'	100'	100'						
LOT WIDTH	50'	42'-6"	42'-6"						
FRONT YARD SETBACK		12'-0"	12'-0"						
REAR YARD SETBACK		14'-6"	14'-6"						
LEFT SIDE YARD SETBACK:		8'-7"	8'-7" 5'-4"						
RIGHT SIDE YARD SETBACK:		5'-4"	5'-4"						
FOOTPRINT FLOOR AREA (W/GARAGE)		1655 SF	1655 SF						
LOT COVERAGE (%)	50%	39%	39%						
GARAGE/WORKSHOP SIZE		285 SF	285 SF						
MAX. BLDG HEIGHT	30'	±19'-0"	27'-6"						
NUMBER OF FLOORS		1	2						
SEPARATION BETWEEN MAIN HOUSE/GARAGE	MIN. 6"	4'-6"	4'-6"						
NUMBER OF OFF STREET PARKING SPACES	MIN. 2	2	2						
DRIVEWAY WIDTH		8'-6"	8'-6"						
TOTAL USABLE OPEN SPACE		±2595 SF	±2595 SF						

### SHEET INDEX

TITLE PAGE & PROJECT INFO DESIGN NOTICE

SITE PLANS

A1.2

A2.0 MAIN FLOOR PLANS & SCHEDULES A2.1

PROPOSED UPPER FLOOR PLAN & SCHEDULES

ROOF PLANS & DETAILS A2.2

A3.0 EXISTING EXTERIOR ELEVATIONS PROPOSED EXTERIOR ELEVATIONS

Drawn By BRADY DILLON 2023-744654 Issues 🦳 Revisions 🛆 2023-12-01 PLANNING SUBMITTAL

> RESIDENTIAL RENOVATION
> 337 SANTA CLARA AVENUE ALAMEDA, CA 94501

> > TITLE PAGE & **PROJECT INFO**


EXISTING


EACH EXPANSION JOINT

EQUAL EQUIPMENT EACH WAY EACH FACE

LAT BAR FURNISHED BY OWNER



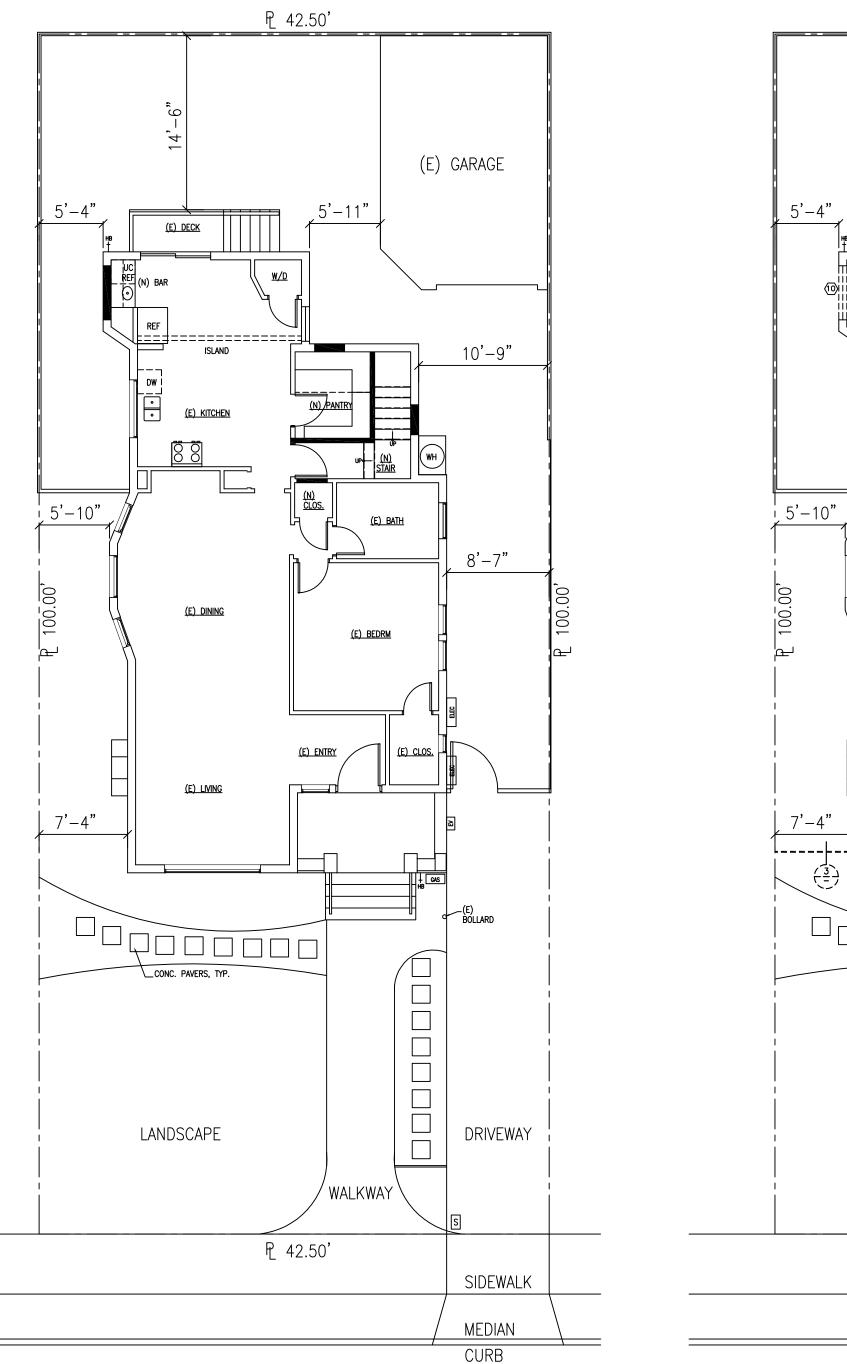

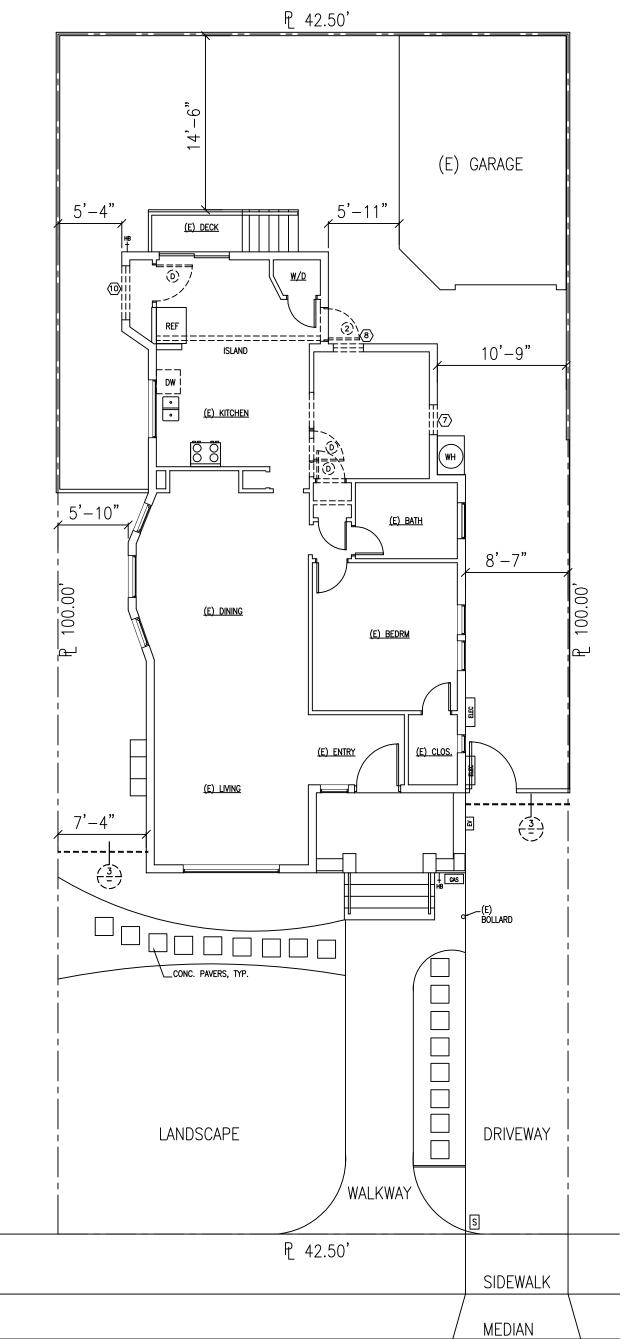





(E) WALL TO BE REMOVED


(E) WALL TO REMAIN

(N) WALL, 2X4 (OR MATCH (E)) FRAMING @ 16" OC, GYP. BD. 2X6 FRAMING @ PLUMBING WALLS. GYP BD FASTENED 6" OC AT EDGES & 12" OC FIELD.

PROVIDE STORM WATER DRAINAGE MANAGEMENT PROTECTIONS DURING CONSTRUCTION TO PREVENT EROSION & RETAIN SOIL RUNOFF ON THE SITE PER CALGREEN 4.106.2.

MIN.: FIBER ROLL 8"Ø TO P, PLACED 2-4" WITHIN GRADE. PROVIDE STAKING ON DRY SIDE OF ROLL AS NEEDED, SPACED 4' MIN. CONTRACTOR IS RESPONSIBLE FOR DESIGN, INSTALLATION & MAINTENANCE OF THE STORM WATER MANAGEMENT PROTECTION TO COMPLY WITH CALGREEN REQUIREMENTS.

PROVIDE POSITIVE DRAINAGE AWAY FROM STRUCTURE, MIN 2% SLOPE TO APPD SITE DRAINAGE LOCATION. SURFACE WATER SHALL DIVERT AWAY FROM STRUCTURE & SHALL NOT ENTER BLDG PER CALGREEN 4.106.3

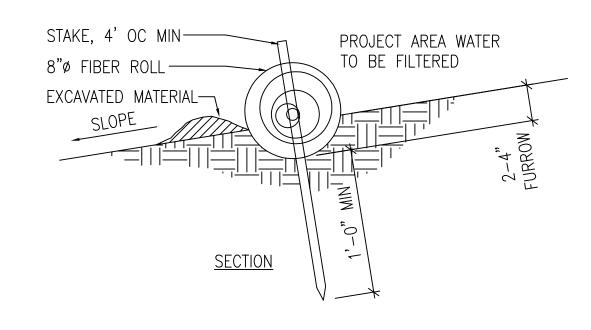

3 FIBER ROLL DETAIL 1 1/2"=1'-0"



NORTH \ EXISTING SITE PLAN 1/8"=1'-0"

CURB

DANIEL HOY, AIA
ARCHITECTURE
314 PACIFIC AVENUE
ALAMEDA, CALIFORNIA 94501
P: 510-520-6528 E : DanielHoyArch@gmail.com

PLANS & SPECIFICATIONS ARE PREPARED AS INSTRUMENTS OF SERVICE FOR THE CLIENT AND ARE THE PROPERTY OF THE ARCHITECT AND SHALL NOT BE USED FOR OTHER WORK WITHOUT THE WRITTEN CONSENT OF THE ARCHITECT.

AVENUE INIA 9450

ORNIA

AMEDA,

37

RESIDENTIAL RENOVATION

Project Number Drawn By 2023—744654 BRADY DILLON Issues Revisions Number Date 1 2023-12-01 PLANNING SUBMITTAL ASHLEY & ANDY AULD—FISHER RESIDENTIAL RENOVATION 337 SANTA CLARA AVENUE ALAMEDA, CA 94501

SITE PLANS

A1.2

WINDOW SCHEDULE									
SYMBOL	QTY	TYPE	MATERIAL (EXT/INT)	RO W	RO HT	CLR W	CLR HT	HT. FROM FIN. FLR.	NOTE
	(E)	DG FIXED	VINYL	_	_	8'-0"	4'-4"	2'-5"	EXISTING TO REMAIN
$\langle 2 \rangle$	(E)	SG FIXED	WOOD	_	_	2'-4"	1'-10"	4'-11"	EXISTING TO REMAIN
3	(E)	SG DH	WOOD	-	_	1'-6"	3'-0"	3'-2"	EXISTING TO REMAIN
4	(E)	DG CSMT	VINYL	_	_	2'-6"	4'-3"	2'-7"	EXISTING TO REMAIN
5	(E)	DG CSMT	VINYL	-	_	2'-6"	4'-3"	2'-7"	EXISTING TO REMAIN
6	(E)	SG SL	ALUM.	_	_	3'-0"	3'-0"	3'-10"	EXISTING TO REMAIN
7	(D)	DEMO	_	_	_	2'-6"	3'-10"	_	TO BE REMOVED
8	(D)	DEMO	_	_	_	2'-6"	3'-10"	_	TO BE REMOVED
9	(N)	DG DH	FG/WD	±2-11"	4'-9"	±2-10"	4'-8"	±2-7"	(N) WINDOW IN (E) FORMER DOOR FRAME
(10)	(D)	DEMO	_	_	_	4'-6"	4'-0"	_	TO BE REMOVED
$\langle 11 \rangle$	(E)	DG SL	VINYL	_	_	4'-10"	3'-8"	4'-1"	EXISTING TO REMAIN
(12)	(E)	DG DH	VINYL	_	_	2'-6"	4'-3"	2'-9"	EXISTING TO REMAIN
(13)	(E)	DG DH	VINYL	_	_	2'-6"	4'-3"	2'-9"	EXISTING TO REMAIN
(14)	(E)	DG DH	VINYL	_	_	2'-6"	4'-3"	2'-9"	EXISTING TO REMAIN


### WINDOW NOTES:

- 1. VIF ALL RO MEASUREMENT REQS. W/WINDOW MANUF. PRIOR TO CONSTRUCTION.
- 2. ALL REPLACEMENTS TO BE MARVIN OR APPD EQ., LOW E, DUAL GLAZE.
- 3. SEE FINISH NOTES FOR ADDITIONAL INFO.
- 4. VIF, PRIOR TO BID, ANY REQD REPAIRS OR REPLACEMENTS.
- 5. PROVIDE "OGEE" LUGS AND/OR TRUE DIVIDED LITES WHERE WINDOW STYLE IS TO MATCH (E).
- 6. NEW WINDOWS TO BE NFRC RATED. SEE T24 REPORT FOR U FACTOR AND SHGC
- REQUIREMENTS.

DOOR SCHEDULE									
SYMBOL	TYPE	WIDTH	HT.	THICK	HARDWARE	NOTE			
D	DEMO DOOR	_	_	_	_	TO BE REMOVED			
E	(E) DOOR	_	_	_	_	TO REMAIN- NO CHANGES			
1	(E) EXT. DOOR	3'-6"	6'-8"	1 3/4"	_	TO REMAIN- NO CHANGES			
2	DEMO EXT. DOOR	2'-7"	_	_	_	TO BE REMOVED FRAME & FINISH @ AREAS AROUND (N) WINDOV			
3	(E) EXT. SL GLASS DOOR PAIR	5'-10"	6'-8"	_	_	TO REMAIN- NO CHANGES			
4	(N) INT. DOOR	2'-8"	6'-8"	1 3/8"	PASSAGE	SOLID CORE, 2 HINGE			
5	(N) INT. DOOR	2'-8"	6'-8"	1 3/8"	PASSAGE	SOLID CORE, 2 HINGE			

### DOOR NOTES:

- VERIFY ALL DIMS W/OWNER PRIOR TO FINAL FRAMING.
- 2. ALL DOOR STYLES TO BE APPD BY OWNER PRIOR TO ORDERING.
- 3. (N) TRIMS TO BE APPD BY OWNER.

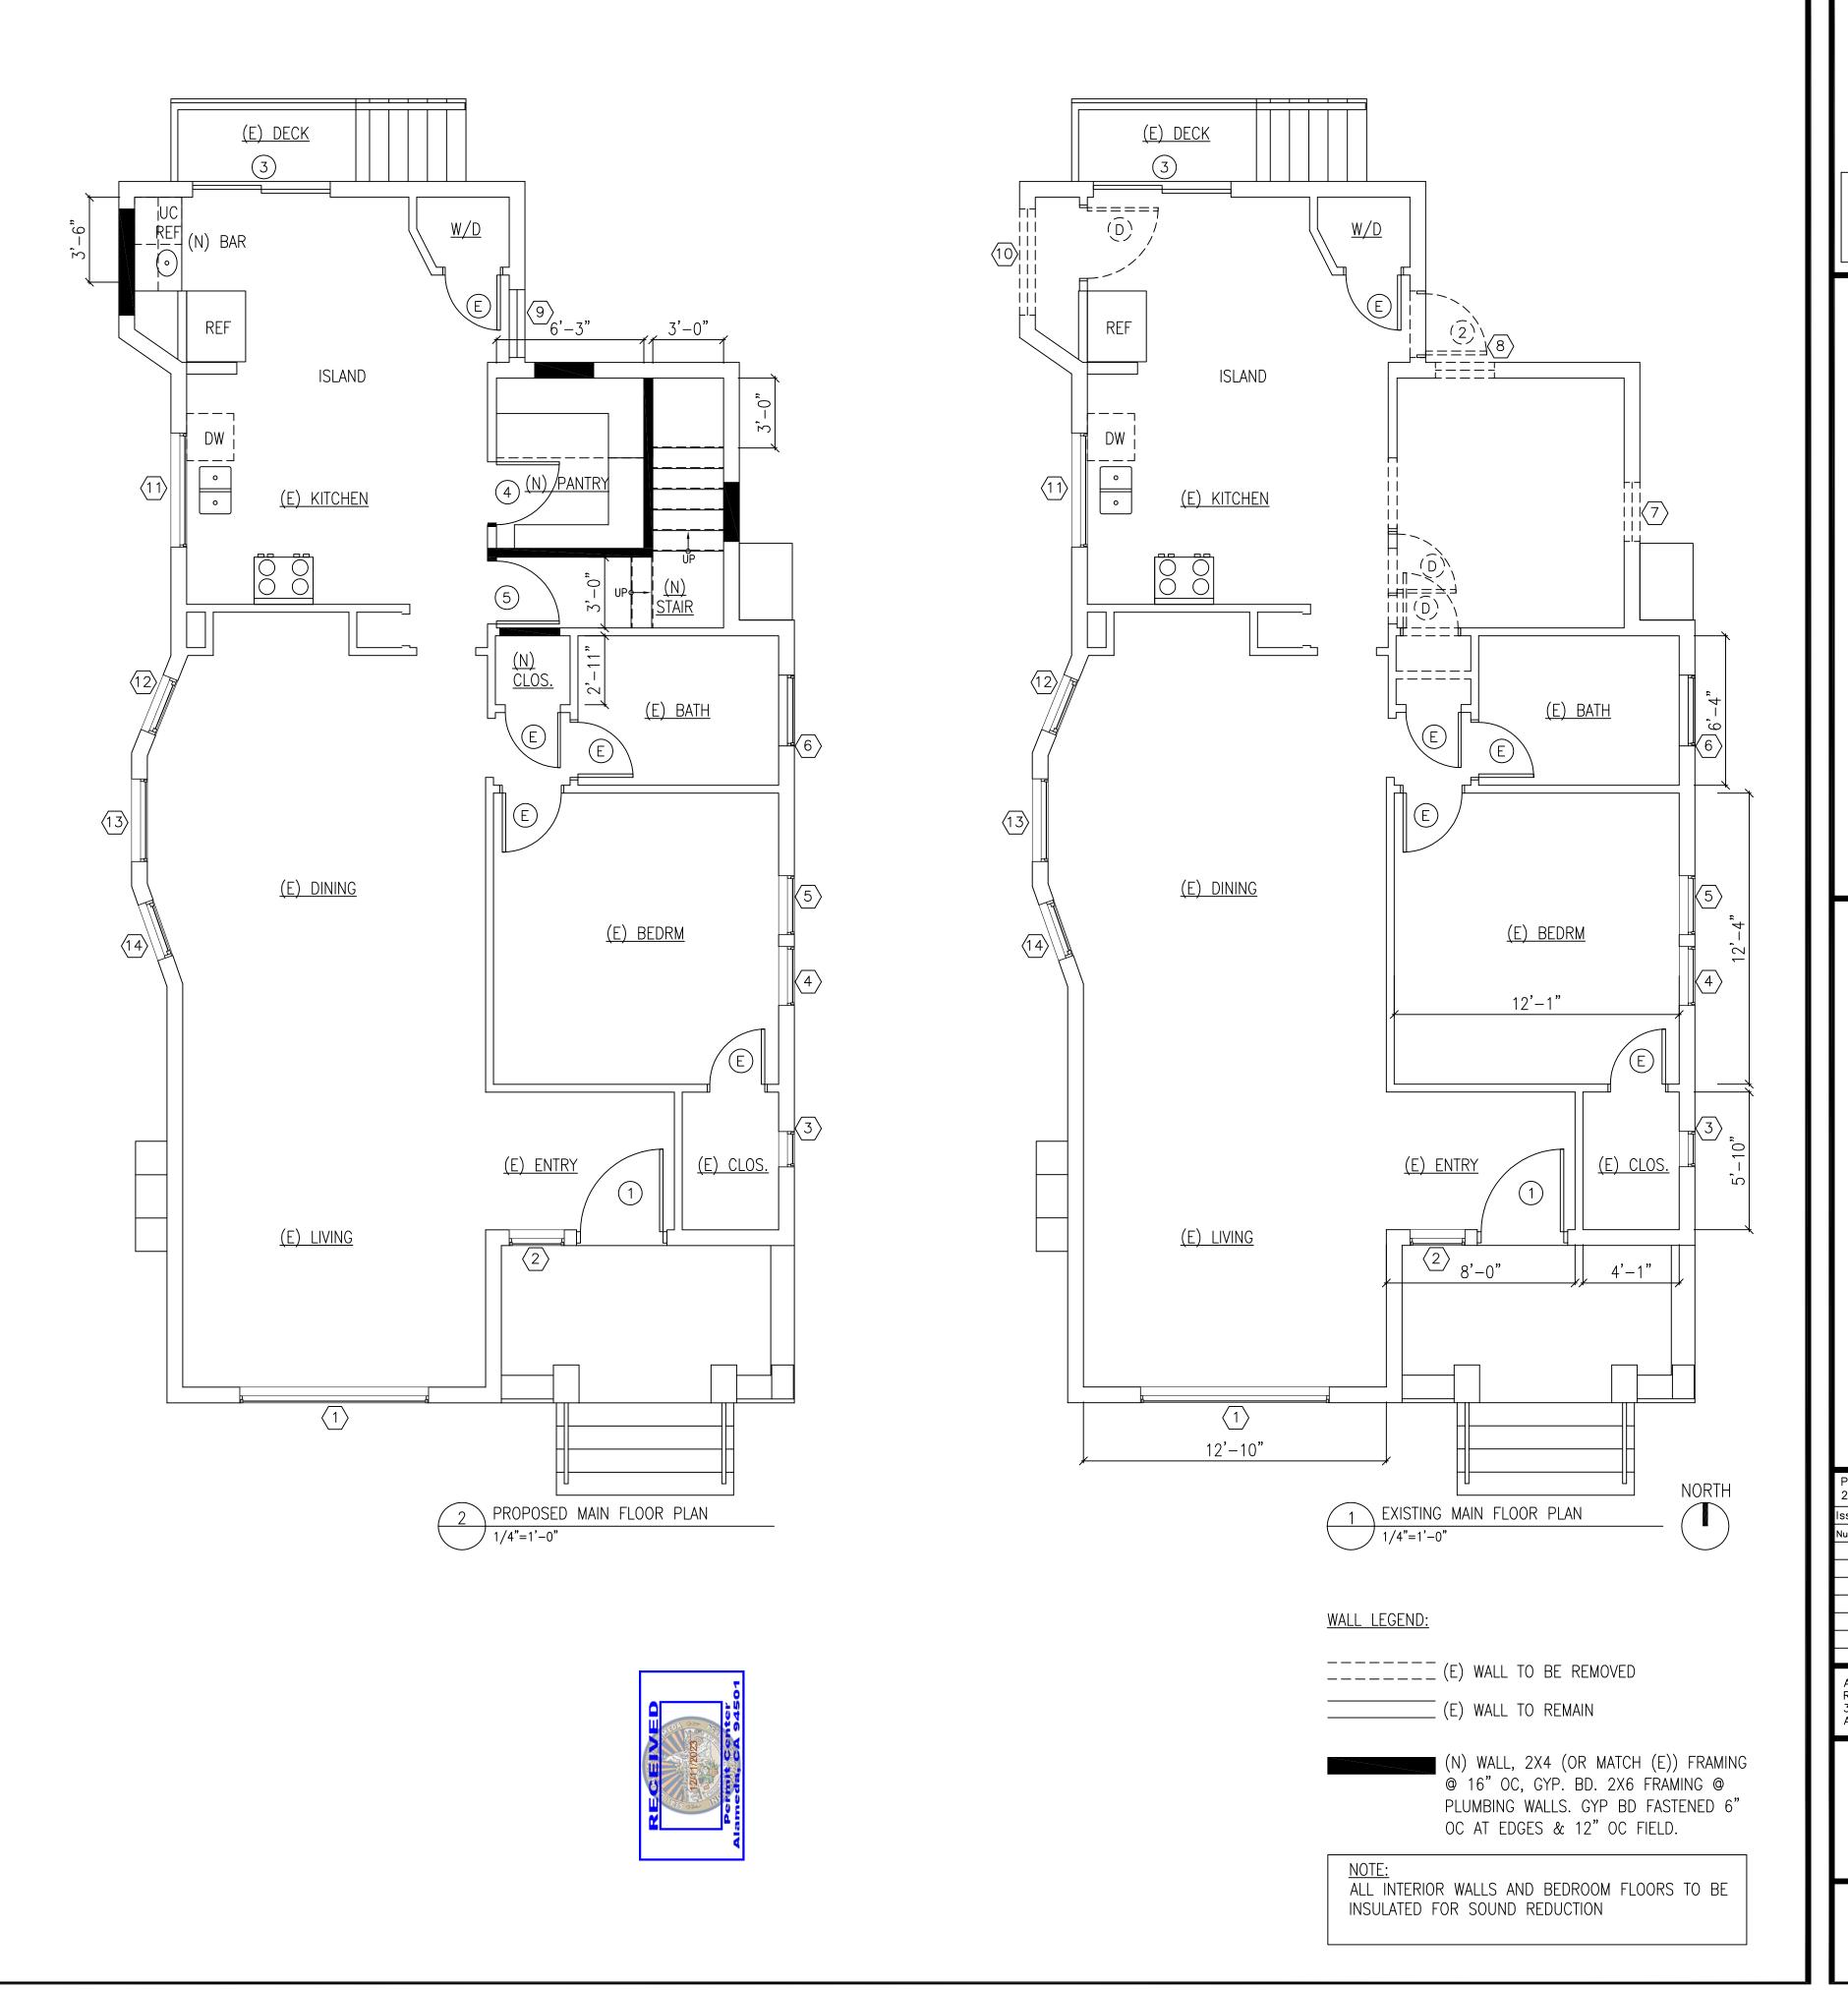

DANIEL HOY, AIA
ARCHITECTURE
314 PACIFIC AVENUE
ALAMEDA, CALIFORNIA 94501
P: 510-520-6528
E: DanielHoyArch@gmail.com



PLANS & SPECIFICATIONS ARE PREPARED AS INSTRUMENTS OF SERVICE FOR THE CLIENT AND ARE THE PROPERTY OF THE ARCHITECT AND SHALL NOT BE USED FOR OTHER WORK WITHOUT THE WRITTEN CONSENT OF THE ARCHITECT.

NTA CLARA AVENUE
DA, CALIFORNIA 9450
RESIDENTIAL
RENOVATION

337 SANT ALAMEDA,

Project Number 2023-744654 BRADY DILLON DH

Issues Revisions 
Number Date Description

1 2023-12-01 PLANNING SUBMITTAL

ASHLEY & ANDY AULD—FISHER RESIDENTIAL RENOVATION 337 SANTA CLARA AVENUE ALAMEDA, CA 94501

MAIN FLOOR
PLANS & SCHEDULES


A2.0

WINDOW SCHEDULE										
SYMBOL	QTY	TYPE	MATERIAL (EXT/INT)	RO W	RO HT	CLR W	CLR HT	HT. FROM FIN. FLR.	NOTE	
(15)	(N)	DG AWN	FG/WD	3'-1"	1'-8"	3'-0"	1'-7"	5'-4"		
(16)	(N)	DG AWN	FG/WD	3'-1"	1'-8"	3'-0"	1'-7"	5'-4"		
(17)	(N)	DG AWN	FG/WD	3'-1"	1'-8"	3'-0"	1'-7"	5'-4"		
(18)	(N)	DG DH	FG/WD	3'-1"	4'-9"	3'-0"	4'-8"	2'-3"		
(19)	(N)	DG DH	FG/WD	3'-1"	6'-1"	3'-0"	6'-0"	2'-0"	TEMPERED GLASS. 2'-0"AFF © NEAREST STAIR TREAD	
20	(N)	DG DH	FG/WD	3'-7"	4'-9"	3'-6"	4'-8"	2'-3"		
21	(N)	DG DH	FG/WD	3'-7"	5'-2"	3'-6"	5'-1"	1'-10"	EGRESS	
22	(N)	DG DH	FG/WD	3'-7"	5'-2"	3'-6"	5'-1"	1'-10"	EGRESS	
23	(N)	DG DH	FG/WD	3'-7"	4'-9"	3'-6"	4'-8"	2'-3"		
24	(N)	DG DBL CSMT	FG/WD	5'-5"	4'-1"	5'-4"	4'-0"	2'-9"	EGRESS	
25	(N)	DG DH	FG/WD	3'-7"	5'-2"	3'-6"	5'-1"	1'-10"	EGRESS	
26	(N)	DG DH	FG/WD	3'-7"	5'-2"	3'-6"	5'-1"	1'-10"	EGRESS	
27	(N)	SKYLT	MTL	_	ı	1'-10"	3'-10"	ı	VELUX DECK MTD. VSE CO6 W/SCREEN (OR EQ.)	
28	(N)	SKYLT	MTL	_	_		3'-10"	_	VELUX DECK MTD. VSE CO6 W/SCREEN (OR EQ.)	
29	(N)	SKYLT	MTL	_	_		3'-10"	_	VELUX DECK MTD. VSE CO6 W/SCREEN (OR EQ.)	
30	(N)	SKYLT	MTL	_	_		3'-10"	_	VELUX DECK MTD. VSE CO6 W/SCREEN (OR EQ.)	


- 1. VIF ALL RO MEASUREMENT REQS. W/WINDOW MANUF. PRIOR TO CONSTRUCTION.
- 2. ALL REPLACEMENTS TO BE MARVIN OR APPD EQ., LOW E, DUAL GLAZE.
- 3. SEE FINISH NOTES FOR ADDITIONAL INFO.
- 4. VIF, PRIOR TO BID, ANY REQD REPAIRS OR REPLACEMENTS.
- 5. PROVIDE "OGEE" LUGS AND/OR TRUE DIVIDED LITES WHERE WINDOW STYLE IS TO MATCH (E). 6. NEW WINDOWS TO BE NFRC RATED. SEE T24 REPORT FOR U FACTOR AND SHGC REQUIREMENTS.

DO	DOOR SCHEDULE										
SYMBOL	TYPE	WIDTH	HT.	THICK	HARDWARE	NOTE					
6	(N) INT. SC POCKET DR PR	6'-0"	6'-8"	1 3/8"	PULLS	OWNER APP'D. STYLE W/TRACK					
7	(N) SC INT. DR	2'-8"	6'-8"	1 3/8"	PRIVACY	2 HINGE OWNER APP'D. STYLE					
8	(N) SC INT. DR	2'-8"	6'-8"	1 3/8"	PRIVACY	2 HINGE OWNER APP'D. STYLE					

- 1. VERIFY ALL DIMS W/OWNER PRIOR TO FINAL FRAMING.
- 2. ALL DOOR STYLES TO BE APPD BY OWNER PRIOR TO ORDERING.
- 3. (N) TRIMS TO BE APPD BY OWNER.

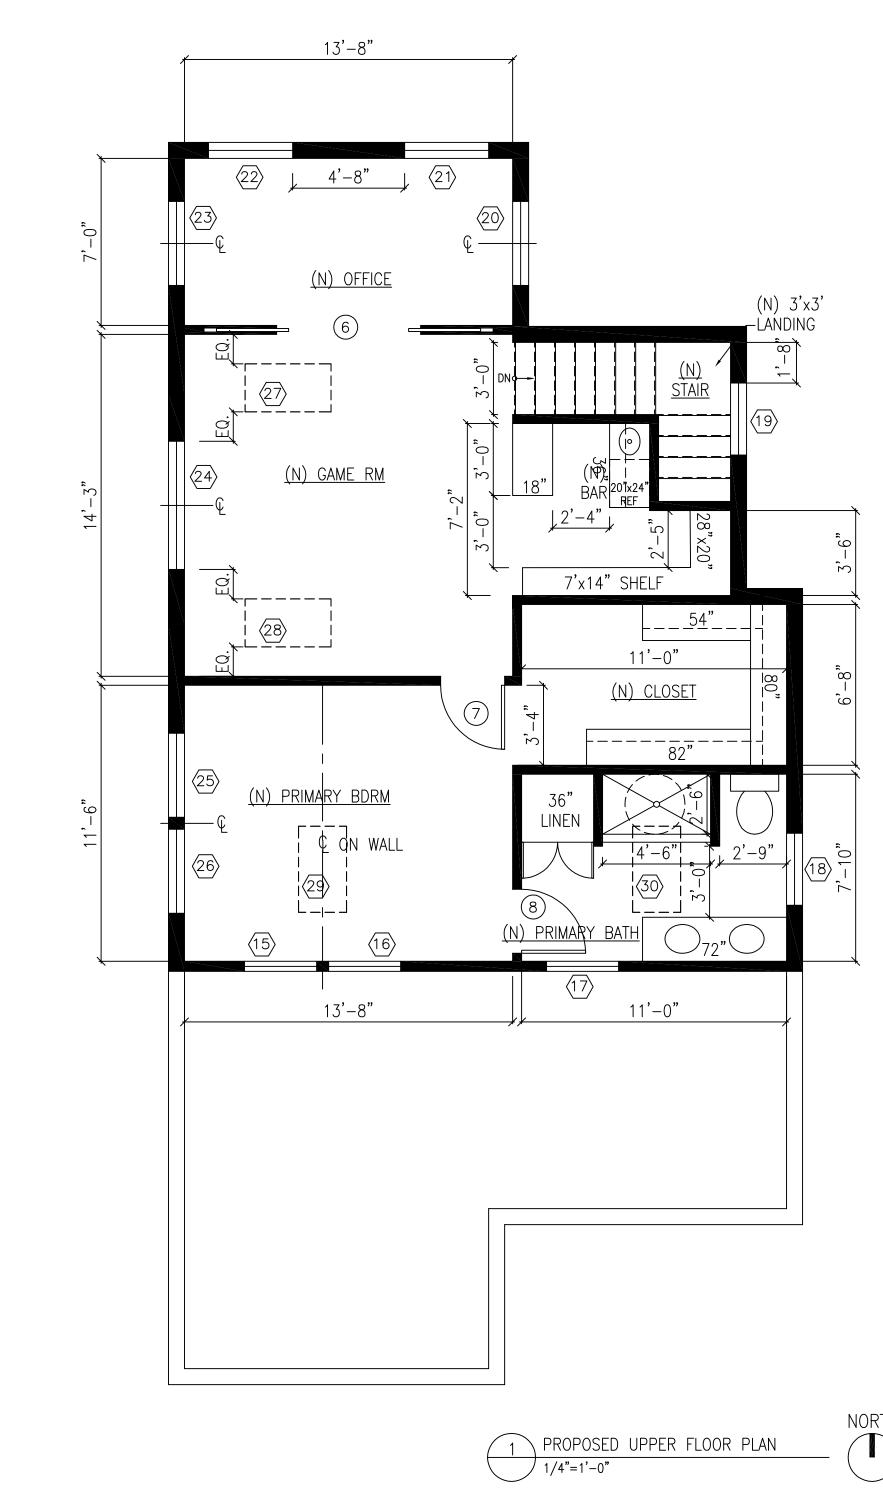



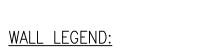


\_\_\_\_\_ (E) WALL TO BE REMOVED

\_\_\_\_\_ (E) WALL TO REMAIN

(N) WALL, 2X4 (OR MATCH (E)) FRAMING @ 16" OC, GYP. BD. 2X6 FRAMING @ PLUMBING WALLS. GYP BD FASTENED 6" OC AT EDGES & 12" OC FIELD.

NOTE: ALL INTERIOR WALLS AND BEDROOM FLOORS TO BE INSULATED FOR SOUND REDUCTION

DANIEL HOY, AIA
ARCHITECTURE
314 PACIFIC AVENUE
ALAMEDA, CALIFORNIA 94501
P: 510-520-6528
E: DanielHoyArch@gmail.com

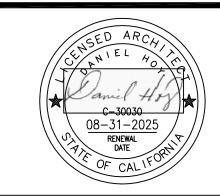

PLANS & SPECIFICATIONS ARE PREPARED AS INSTRUMENTS OF SERVICE FOR THE CLIENT AND ARE THE PROPERTY OF THE ARCHITECT AND SHALL NOT BE USED FOR OTHER WORK WITHOUT THE WRITTEN CONSENT OF THE ARCHITECT.

37 SANTA AMEDA, C.

337 ALAN

# CLARA AVENUE ALIFORNIA 9450

RESIDENTIAL RENOVATION


Project Number Drawn By Checked By 2023—744654 BRADY DILLON DH 
 Issues
 ☐ Revisions

 Number
 Date


 ☐ 2023-12-01
 PLANNING SUBMITTAL

ASHLEY & ANDY AULD—FISHER RESIDENTIAL RENOVATION 337 SANTA CLARA AVENUE ALAMEDA, CA 94501

PROPOSED UPPER FLOOR PLAN & SCHEDULES

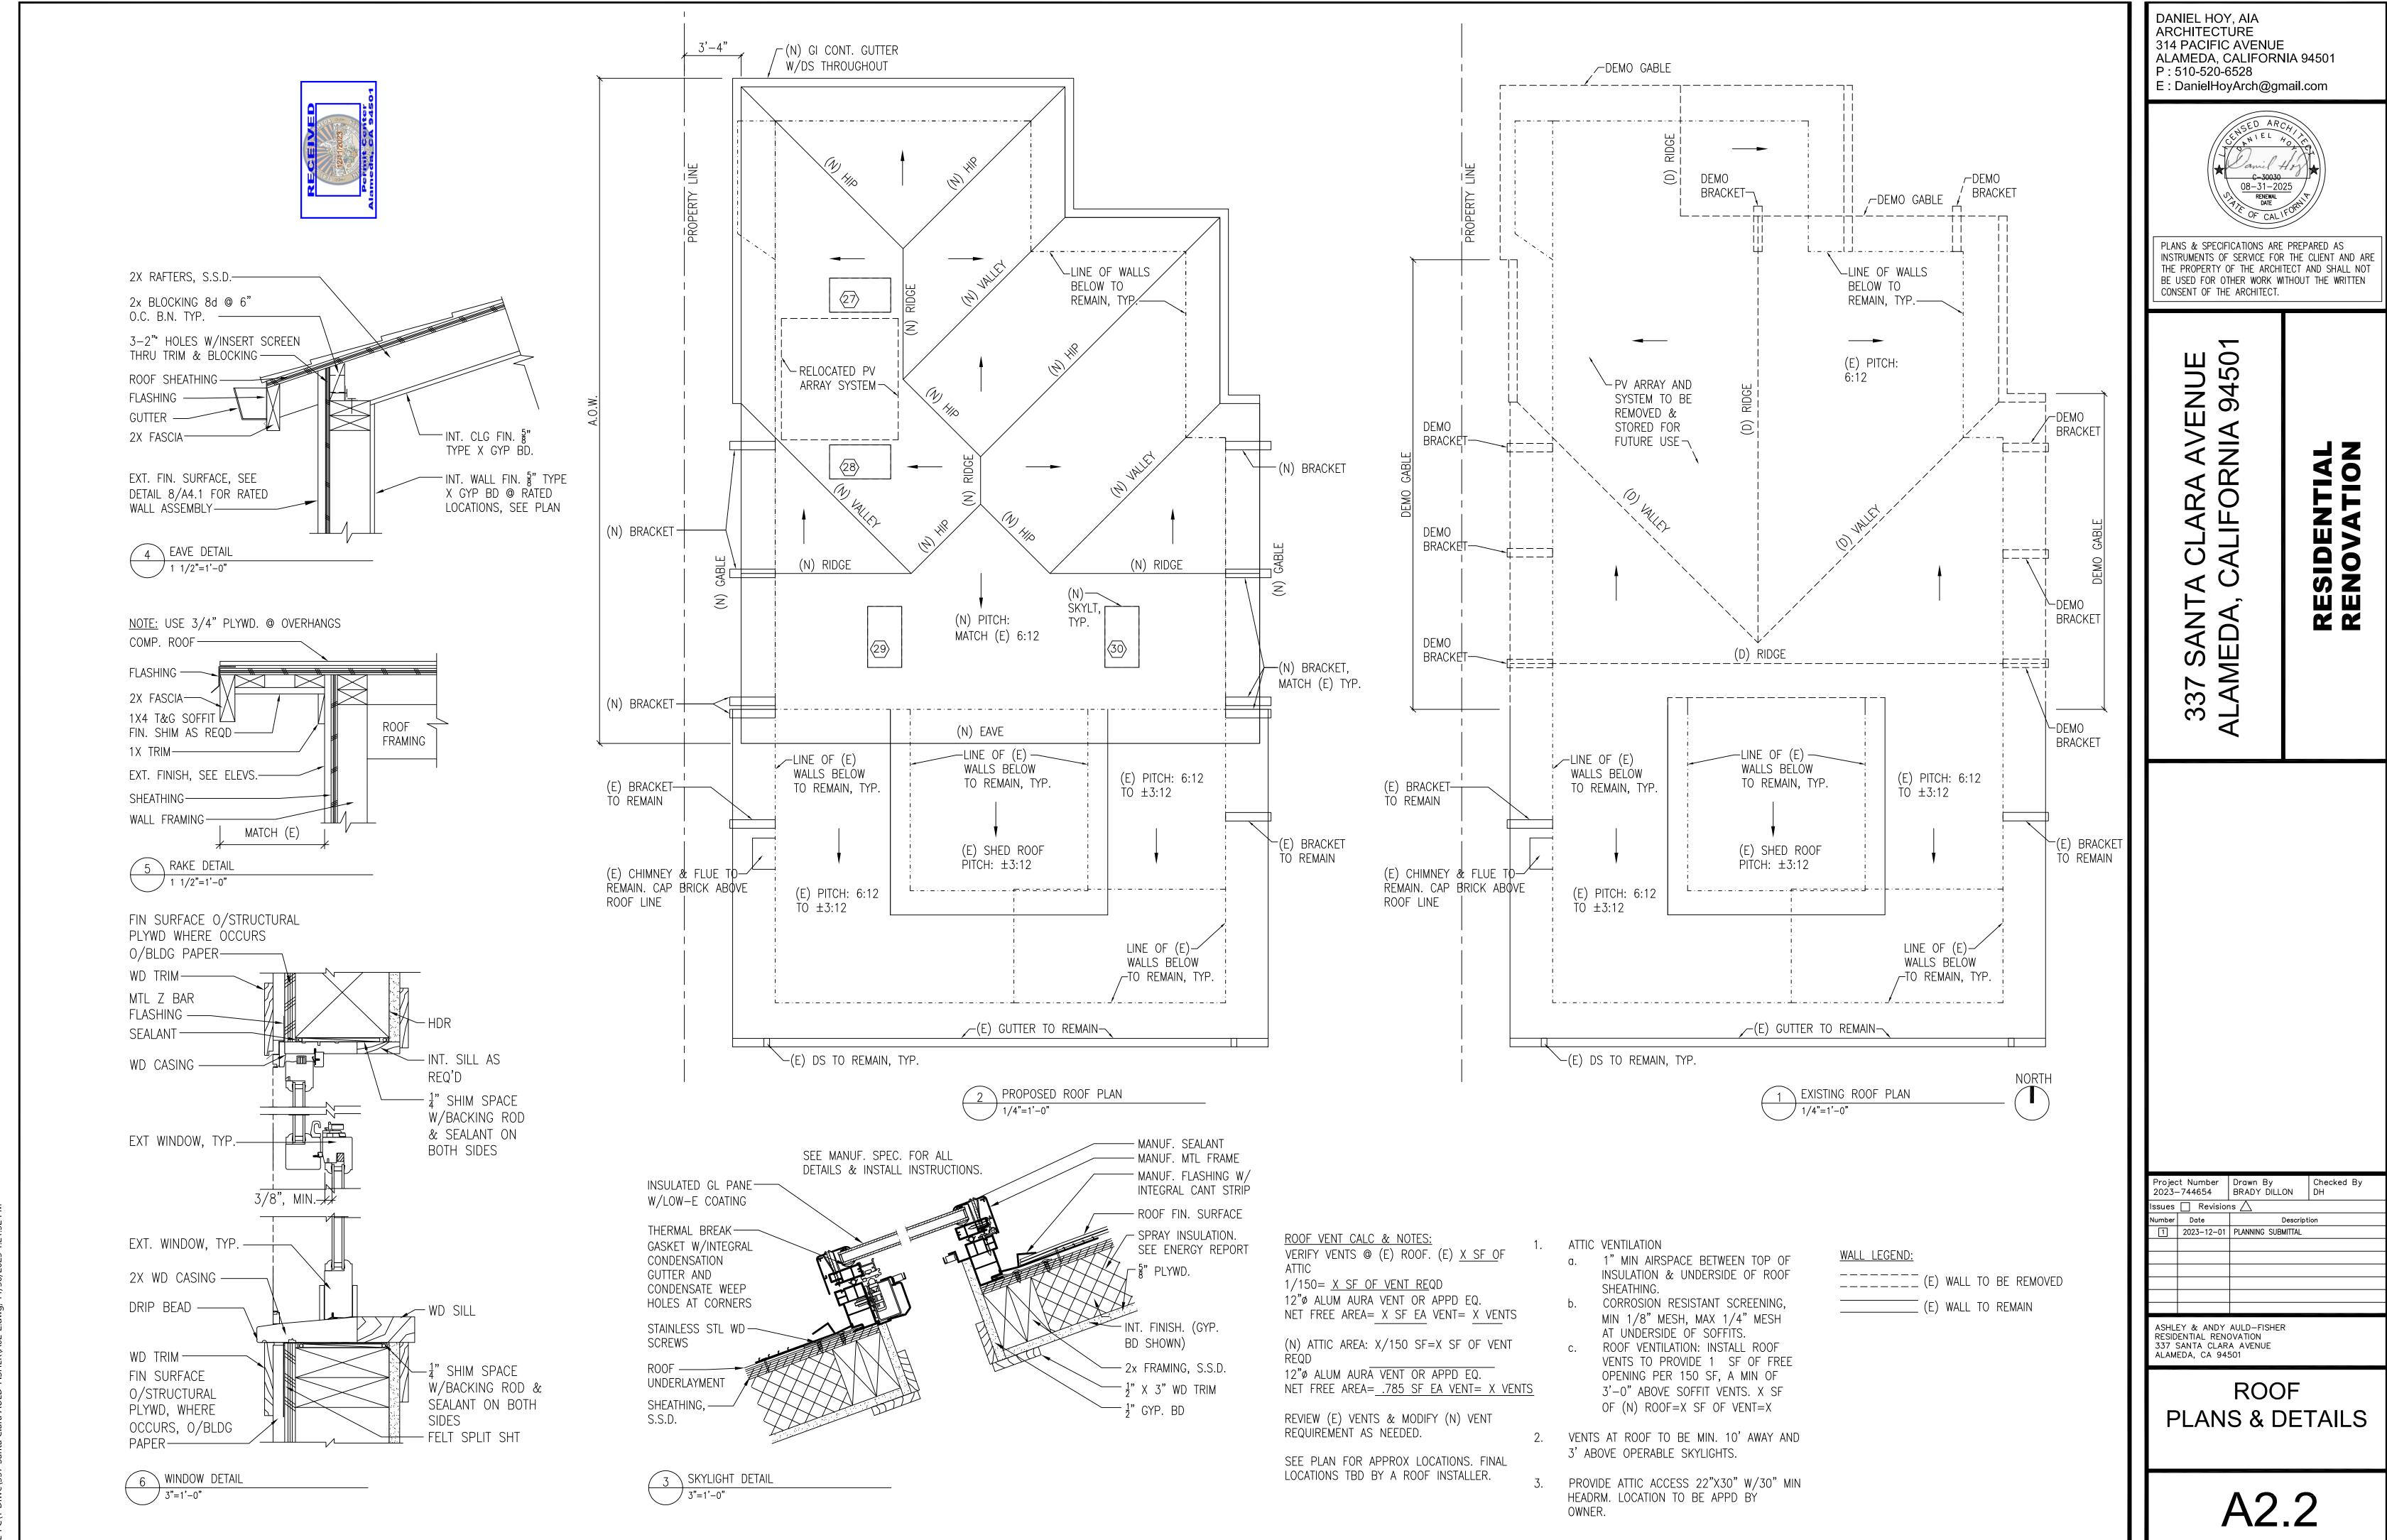

\\DANIEL-PC\Y Drive\337 Santa Clara AULD-FISHER\A02-2.dwg, 11/30

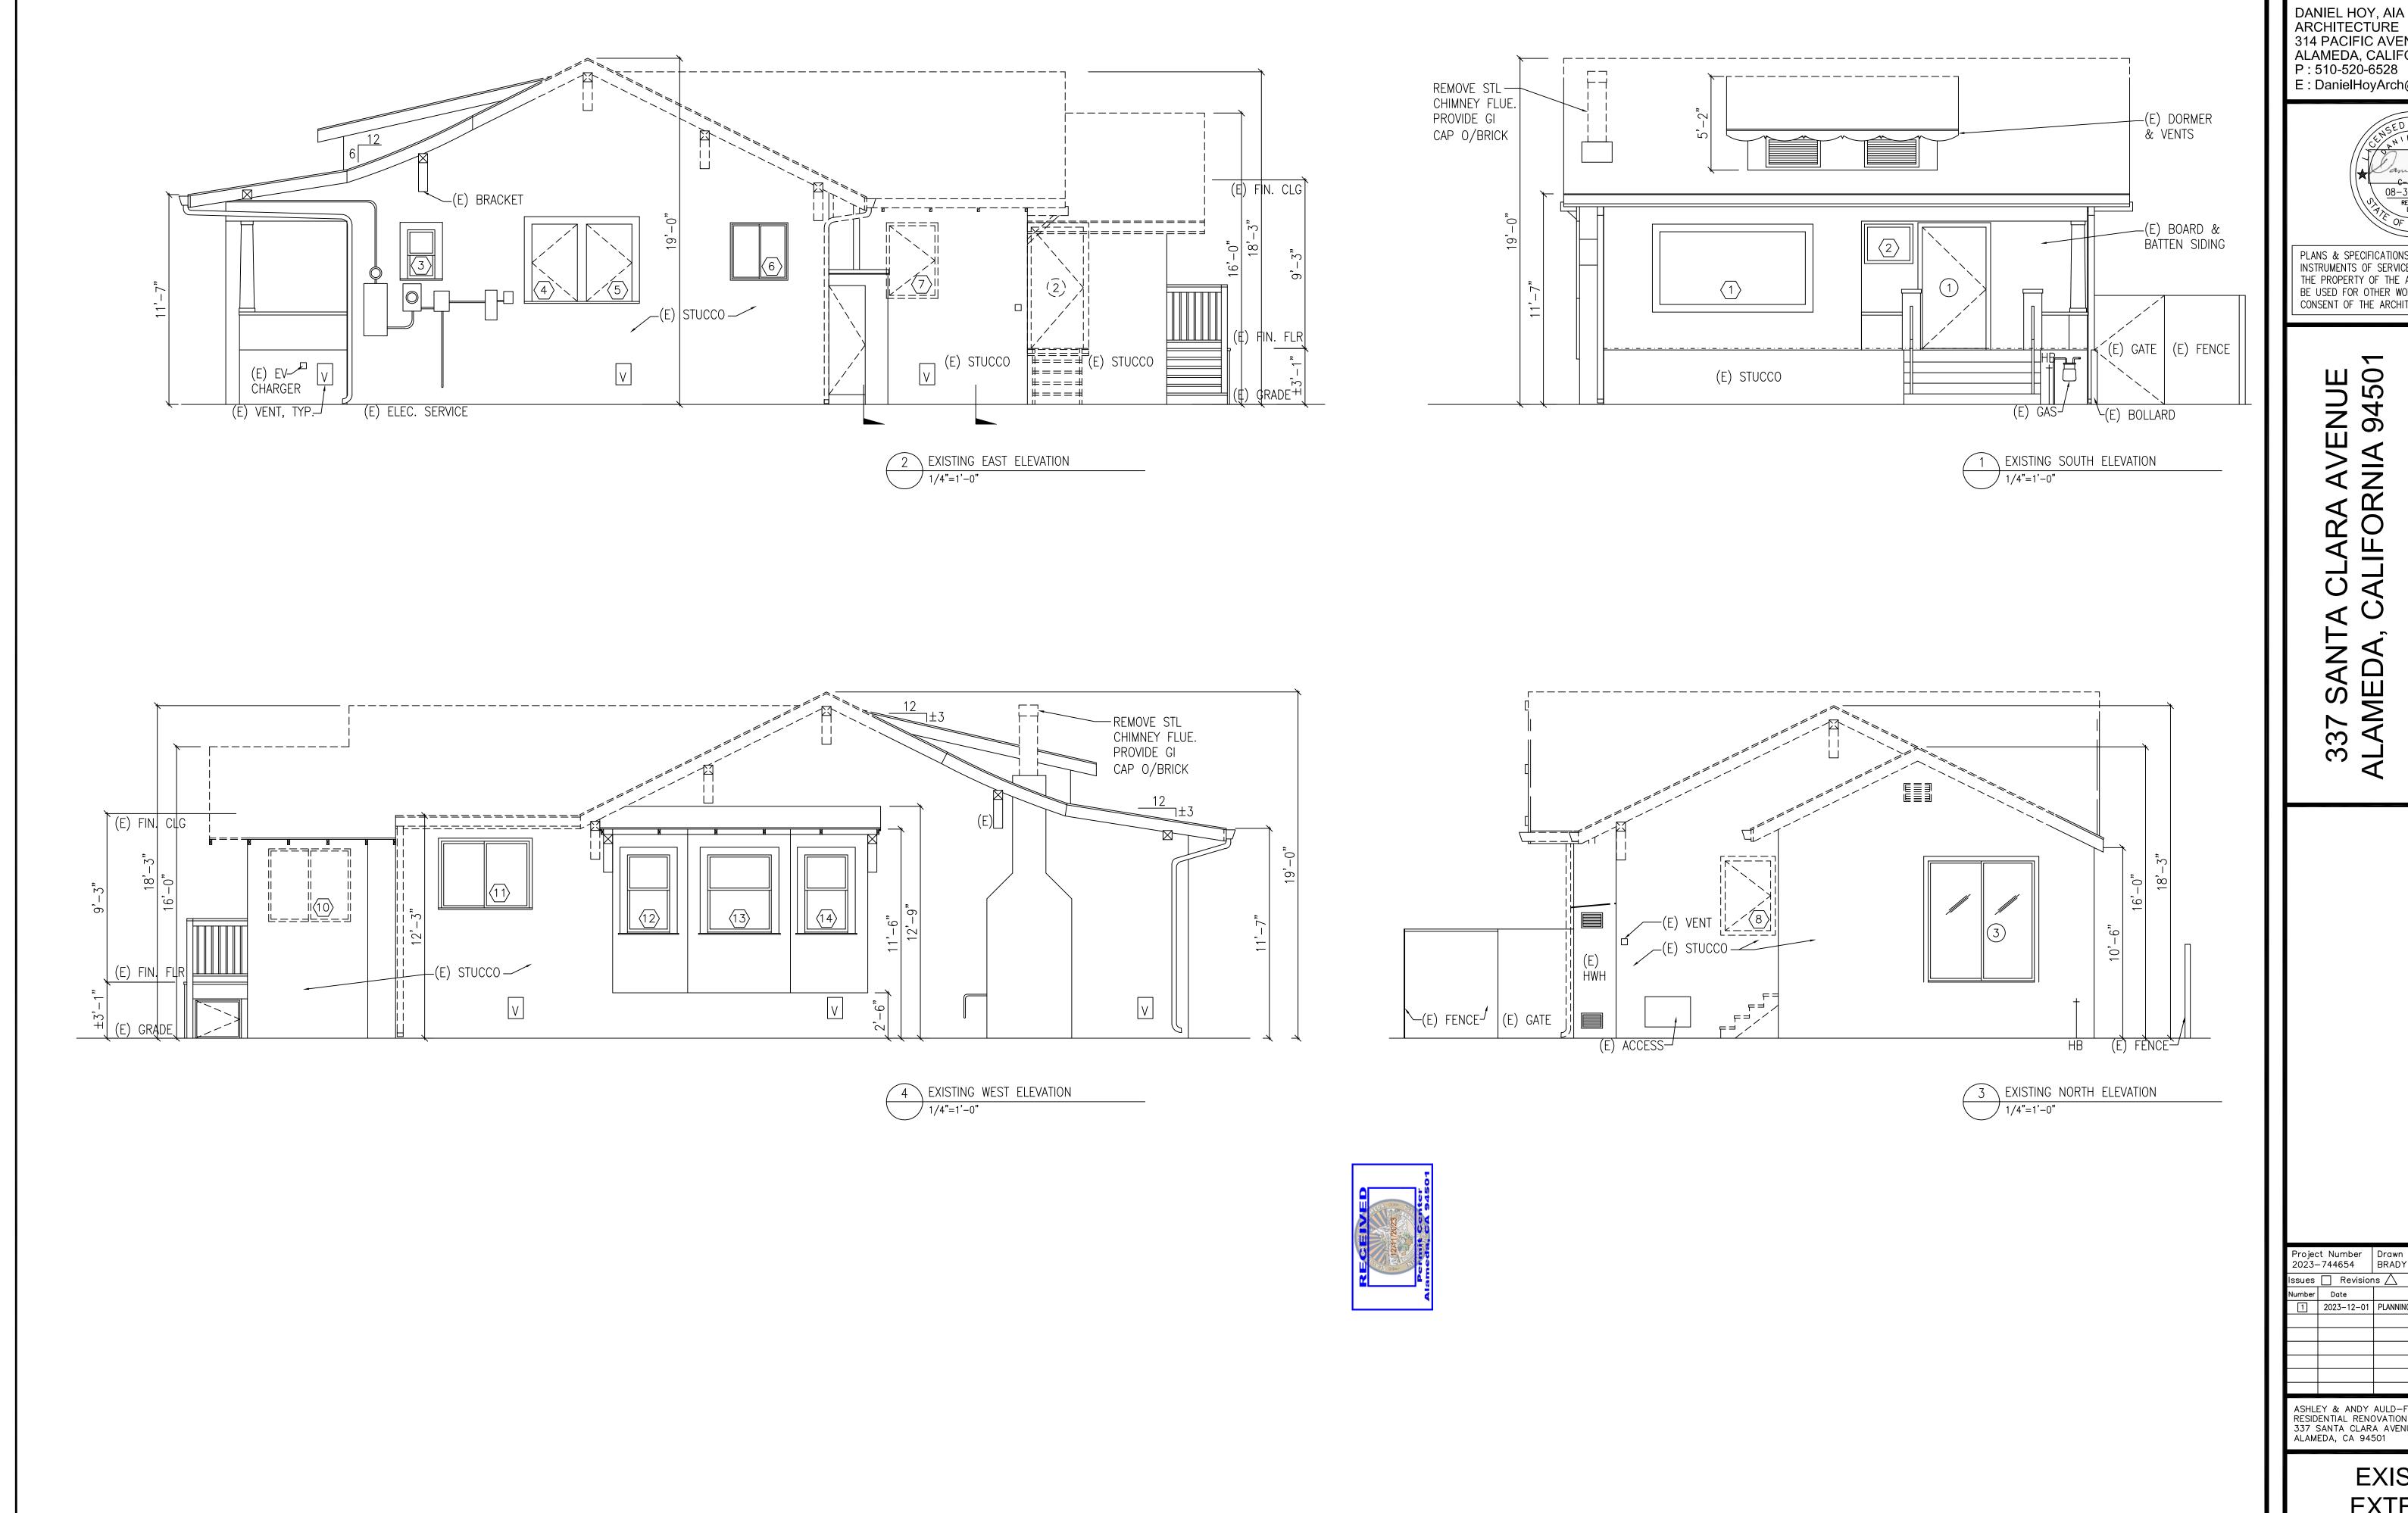

ARCHITECTURE
314 PACIFIC AVENUE
ALAMEDA, CALIFORNIA 94501
P: 510-520-6528 E : DanielHoyArch@gmail.com PLANS & SPECIFICATIONS ARE PREPARED AS INSTRUMENTS OF SERVICE FOR THE CLIENT AND ARE THE PROPERTY OF THE ARCHITECT AND SHALL NOT BE USED FOR OTHER WORK WITHOUT THE WRITTEN CONSENT OF THE ARCHITECT. AVENUE INIA 94501 Project Number Drawn By 2023—744654 BRADY DILLON Issues Revisions Number Date 1 2023-12-01 PLANNING SUBMITTAL ASHLEY & ANDY AULD—FISHER RESIDENTIAL RENOVATION 337 SANTA CLARA AVENUE ALAMEDA, CA 94501 **EXISTING** 

**EXTERIOR** 

**ELEVATIONS** 

A3.0



\\DANIEL-PC\V Drive\337 Santa Clara Alli D-FISHER\A03-1 dwg 11/30