DESCRIPTION OF WORK

NEW PORCH DECK AND STAIRS. LARGER ENTRY LANDING TO ACCOMMODATE

CODE SUMMARY

OCCUPANCY TYPE: CONSTRUCTION TYPE

SPRINKLERED: EXISTING BUILDING NOT SPRINKLERED

CALIFORNIA RESIDENTIAL BUILDING CODE

CALIFORNIA BUILDING CODE LOCAL AMENDMENTS

ZONING SUMMARY


ZONING TYPE R-1 RESIDENTIAL EXISTING USE: SINGLE FAMILY HOME

PROPERTY SUMMARY

74-466-16 **EXISTING HOUSE AREA:** 1,422 SF **EXISTING LOT AREA:** 7,000 SF LOT SITE COVERAGE: (1422 SF) / 7000 SF= 20.3% < 50% MAX

PARKING SPACES EXISTING: 2-STALLS IN ACCESSORY GARAGE

VICINITY MAP

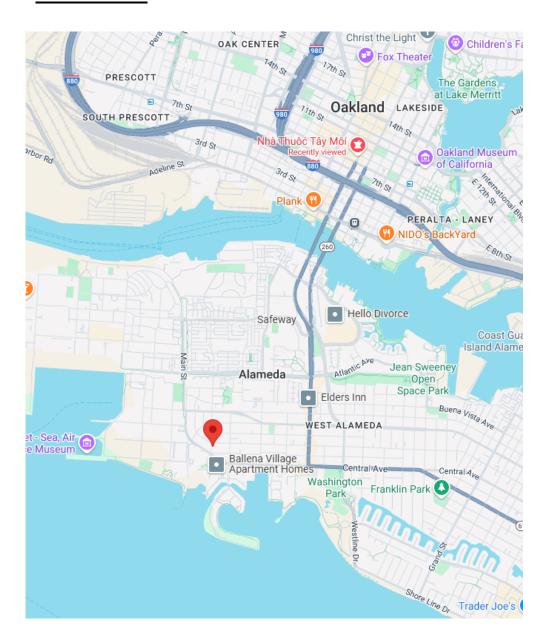

ABBREVIATIONS

| ALUM APPROX ARCH BD BLDG BLKG BLTIN | ALUMINUM APPROXIMATE ARCHITECTURE BOARD BUILDING BLOCKING BUILT-IN | FD FDC FE FEC FR FURN FT FURR | FLOOR DRAIN; FIRE DETECTOR FIRE DEPARTMENT CONNECTION FIRE EXTINGUISHER; FLAT ENAMEL FIRE EXTINGUISHER CABINET FIRE RATED FURNITURE FOOT; FEET FURRING |
|---|---|--|--|
| BM B.O. BOT | BEAM BOTTOM OF BOTTOM | GA GALV | GAGE GALVANIZED |
| CEM | CEMENT | KIT | KITCHEN |
| CL CLG CLO | CENTERLINE CEILING CLOSET | LAV LBS | LAVATORY POUND(S) |
| CLR CMU COL | CLEAR CONCRETE MASONRY UNIT COLUMN | MAX MECH | MAXIMUM MECHANICAL |
| CONC | CONCRETE | MFR MIN | MANUFACTURER MINIMUM |
| DET DIA | DETAIL DIAMETER | MIR MISC | MIRROR MISCELLANEOUS |
| DIM DN DOC DWG | DIMENSION DOWN DOCUMENT DRAWING | (N) NA NIC NO. | NEW NOT APPLICABLE NOT IN CONTRACT NUMBER |
| (E) EL | EXISTING ELEVATION | NOM NTS | NOMINAL NOT TO SCALE |
| ELEV ELEC | ELEVATOR ELECTRICAL | O/ OC | OVER, ON ON CENTER |
| EQ EQPM | EQUAL EQUIPMENT | OFCI | OWNER FURNISHED/ CONTRACTOR INSTALLED |
| EST | ESTIMATE | OPP | OPPOSITE |

MARY HALL PATRONE DECK

1422 3rd STREET ALAMEDA, CA 94501



PHOTO 01 STREET VIEW

| | DRAWING INDEX |
|-----------------|---------------------------|
| SHEET NUMBER | SHEET NAME |
| | |
| A00 | COVER |
| A21 | ENLARGED DECK FLOOR PLANS |
| A30 | ELEVATIONS |

| PL PLAM PLMB PLYWE PSF PSI PT PTD PVC |) | PLATE PLASTIC LAMINATE PLUMBING (ANSI) PLYWOOD POUNDS PER SQUARE FOOT POUNDS PER SQUARE INCH PRESSURE TREATED PAINTED POLYVINYL CHLORIDE |
|---|-------|--|
| QTY | QUANT | ITY |
| RCP RD REF REV RM RO | | REFLECTED CEILING PLAN ROOF DRAIN REFER/ REFRIGERATOR REVISION ROOM ROUGH OPENING |
| SD SECT SF SIM STD STL STOR STRUC | | SMOKE DETECTOR SECTION SQUARE FEET SIMILAR STANDARD; SLOPE TO DRAIN STEEL STORAGE STRUCTURAL |
| THK TYP | | THICK TYPICAL |
| UON UTIL | | UNLESS OTHERWISE NOTED UTILITY |
| VIF | | VERIFY IN FIELD |
| WD | WOOD | |

WT WEIGHT; WOOD THRESHOLD; WALL TYPE

TREX DECK

GENERAL NOTES

1. CONSTRUCTION DOCUMENTS AND SPECIFICATIONS ARE COMPLIMENTARY. WHAT IS SHOWN ON ONE SHALL BE BIDING AS IF REQUIRED BY ALL.. 2. INVALIDITY OF ANY PROVISIONS IN THE CONTRACT DOCUMENTS DOES NOT INVALIDATE THE REMAINING ELEMENTS OF THE CONTRACT. 3. DIGITAL TRANSMISSION OF CAD DRAWINGS OR MODEL, IF REQUESTED, IS FOR REFERENCE ONLY. DESIGN TEAM SHALL BE HELD INDEMNIFIED FOR ALL BUILDING INFORMATION MODEL USE OR RELIANCE 4. CONTRACTOR SHALL REVIEW AND BECOME FAMILIAR WITH THE SITE

CONDITIONS, FIELD DIMENSION AND COORDINATE WORK AS NEEDED WITH CONTRACT DOCUMENTS. 5. CONTRACTOR SHALL ALERT ARCHITECT TO ANY DISCREPANCY IN FIELD

CONDITIONS OR AS DEFINED IN DRAWINGS. 6. CONTRACTOR IS SOLELY RESPONSIBLE FOR CONSTRUCTION MEANS, METHODS, TECHNIQUES, SEQUENCES AND PROCEDURES. 7. CONTRACTOR IS RESPONSIBLE TO OWNER FOR ERRORS OR OMISSIONS OF

THEIR SUBCONTRACTORS, AGENTS OR EMPLOYEES 8. CONTRACTOR SHALL BE RESPONSIBLE FOR INSPECTION OF WORK PROGRESS AND SCHEDULE AND DETERMINE IF SPACE IS IN PROPER CONDITION TO RECEIVE SUBSEQUENT WORK 9. CONTRACTOR SHALL PAY FOR LABOR, MATERIALS, EQUIPMENT, TOOLS,

CONSTRUCTION EQUIPMENT AND MACHINERY, WATER, HEAT, UTILITIES, TRANSPORTATION AND OTHER FACILITIES NECESSARY FOR PROPER EXECUTION AND COMPLETION OF WORK. 10. CONTRACTOR MAY SUBSTITUTE MATERIALS ONLY WITH EXPRESSED CONSENT OF THE OWNER

11. CONTRACTOR WARRANTEES WORK WILL BE FREE OF DEFECTS EXCEPT FOR THOSE INHERENT IN THE QUALITY OF THE WORK 12. CONTRACTOR SHALL COMPLY WITH ALL LOCAL LAWS.

13. CONTRACTOR SHALL PROVIDE NOTICE TO OWNER AND DESIGN TEAM IF CONCEALED OR UNKNOWN CONDITIONS ARE ENCOUNTERED THAT DIFFER FROM THOSE IN CONTRACT DOCUMENTS. 14. CONTRACTOR SHALL SUSPEND OPERATIONS SHOULD THEY ENCOUNTER

HUMAN REMAINS, BURIAL MARKERS, ARCHAEOLOGICAL SITES OR WETLANDS NO INDICATED IN CONTRACT DOCUENTS. OWNER SHALL PROMPTLY TAKE ACTION AS NEEDED FOR GOVERMENTAL AUTHORIZATION REQUIRED TO RESUE WORK. 15. CONTRACTOR SHALL FURNISH CONSTRUCTION SCHEDULE PROMPTLY AFTER BEING AWARDED THE CONTRACT.

16. CONTRACTOR SHALL CONFINE OPERATIONS TO THE SITE AND SITE AREAS AS PERMITTED BY LOCAL CODE. 17. CONTRACTOR SHALL CUT, FIT OR PATCH AS NEEDED TO COMPLETE WORK AND ALLOW COMPONENT ASSEMBLIES TO FIT TOGETHER PROPERLY

18. CONTRACOR SHALL NOT CUT OR ALTER CONSTRUCTION BY THE OWNER OR A SEPARATE CONTRACTOR WITHOUT WRITTEN CONSENT 19. CONTRACTOR SHALL KEEP THE PREMISES AND SURROUNDING AREAS CLEAN AND REMOVE WASTE OR RUBBISH AS NEEDED TO ALLOW PROPER OPERATIONS. 20.CONTRACOR SHALL ALLOW ACCESS TO THE WORK IN PREPARATION AND IN

21. CONTRACTOR INDEMNIFIES OWNER, ARCHITECT AND ENGINEERING CONSULTANTS AGAINST CLAIMS, DAMAGES, LOSES AND EXPENSES ARISING OUT OF OR RESULTING FROM PERFORMANCE OF THE WORK.

LIGHTING NOTES

1. ALL LIGHTS THROUGHOUT THE RESIDENCE, INCLUDING THE GARAGE AND EXTERIOR, SHALL BE HIGH EFFICACY. [CENC 150.0(K)1A]

ELECTRICAL NOTES

1. ALL OUTLETS AFCI UNLESS NOTED AS GFCI. ALL 120-VOLT, SINGLE PHASE, 15- AND 20-AMPERE BRANCH CIRCUITS SUPPLYING OUTLETS OR DEVICES INSTALLED IN DWELLING UNIT BEDROOMS, SUNROOMS, CLOSETS, HALLWAYS, OR SIMILAR ROOMS OR AREAS SHALL BE PROTECTED BY A LISTED ARC-FAULT CIRCUIT INTERRUPTER, COMBINATION-TYPE, INSTALLED TO PROVIDE PROTECTION OF THE BRANCH CIRCUIT. [CEC 210.12(A)] 2. ALL NON-LOCKING TYPE 125-VOLT, 15- AND 20-AMPERE RECEPTACLES SHALL BE LISTED TAMPER-RESISTANT RECEPTACLES. [CEC 406.12]

SANTA CLARA AVE

AREA OF

28' - 6"

14' - 9"

NEW PORCH DECK

phantomarchitecture www.phantomarchitecture.com





PhanTom Architecture Studio 740 Mandana Blvd Oakland, CA 94610 Contact: Michael R Tom, AIA Phone: 415.857.5592 e-mail: mtom@phantomarchitecture.com

Date

07/08/2025

1/8" = 1'-0"

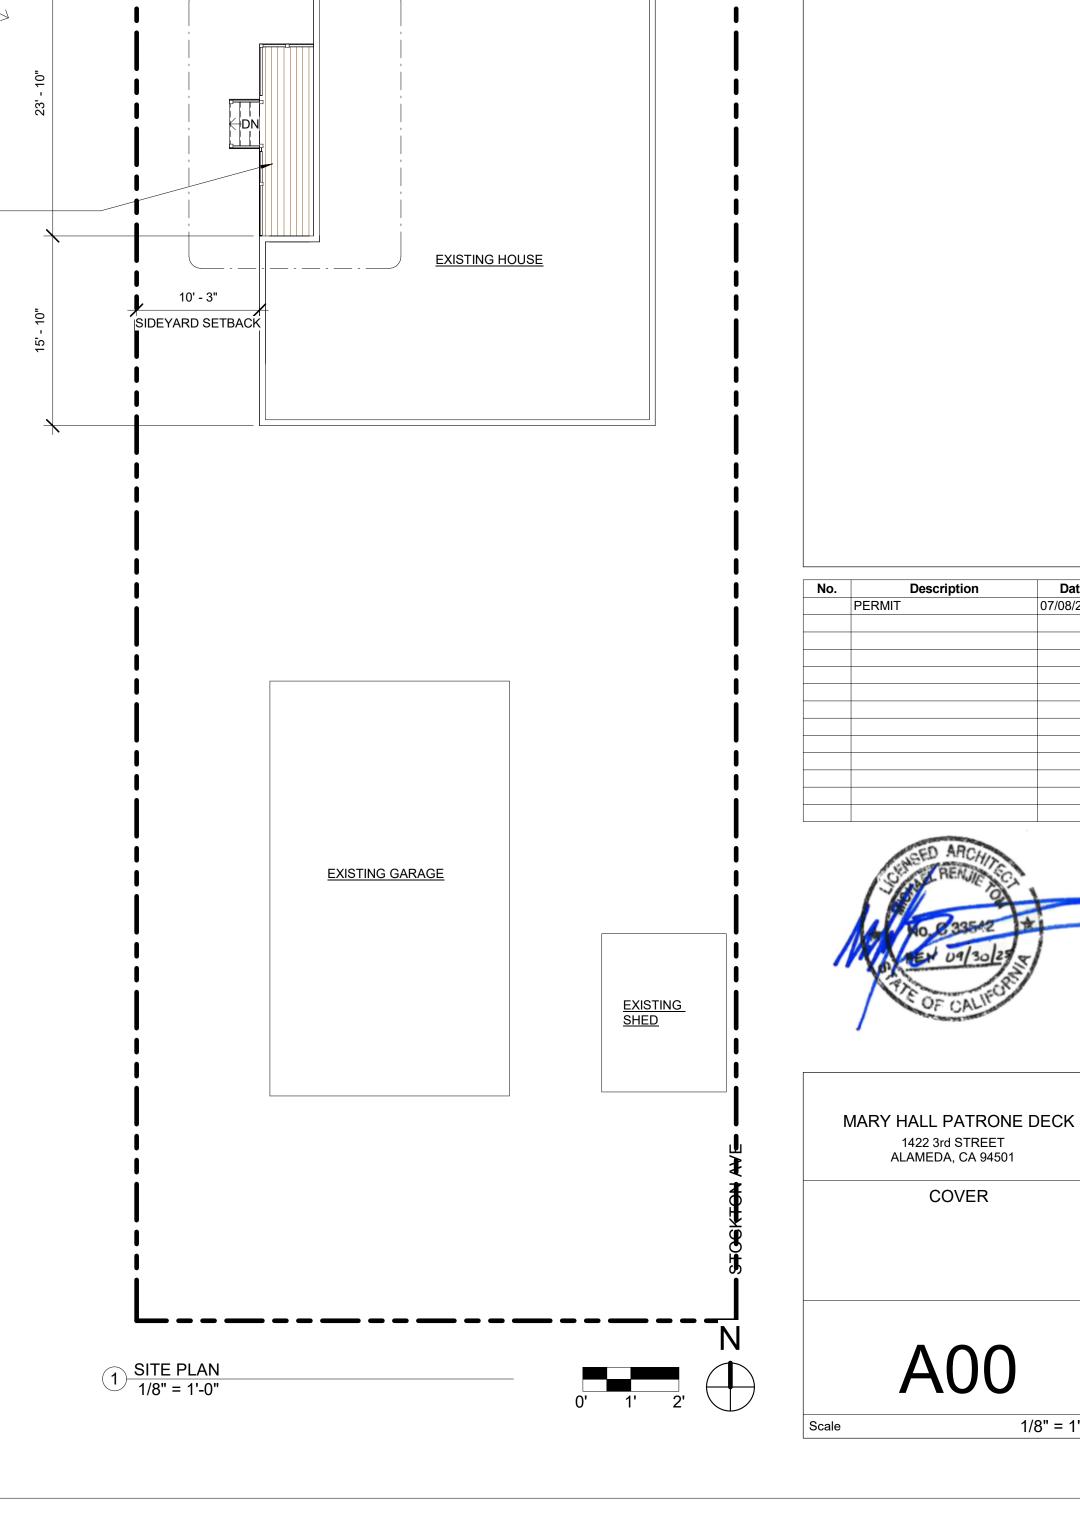

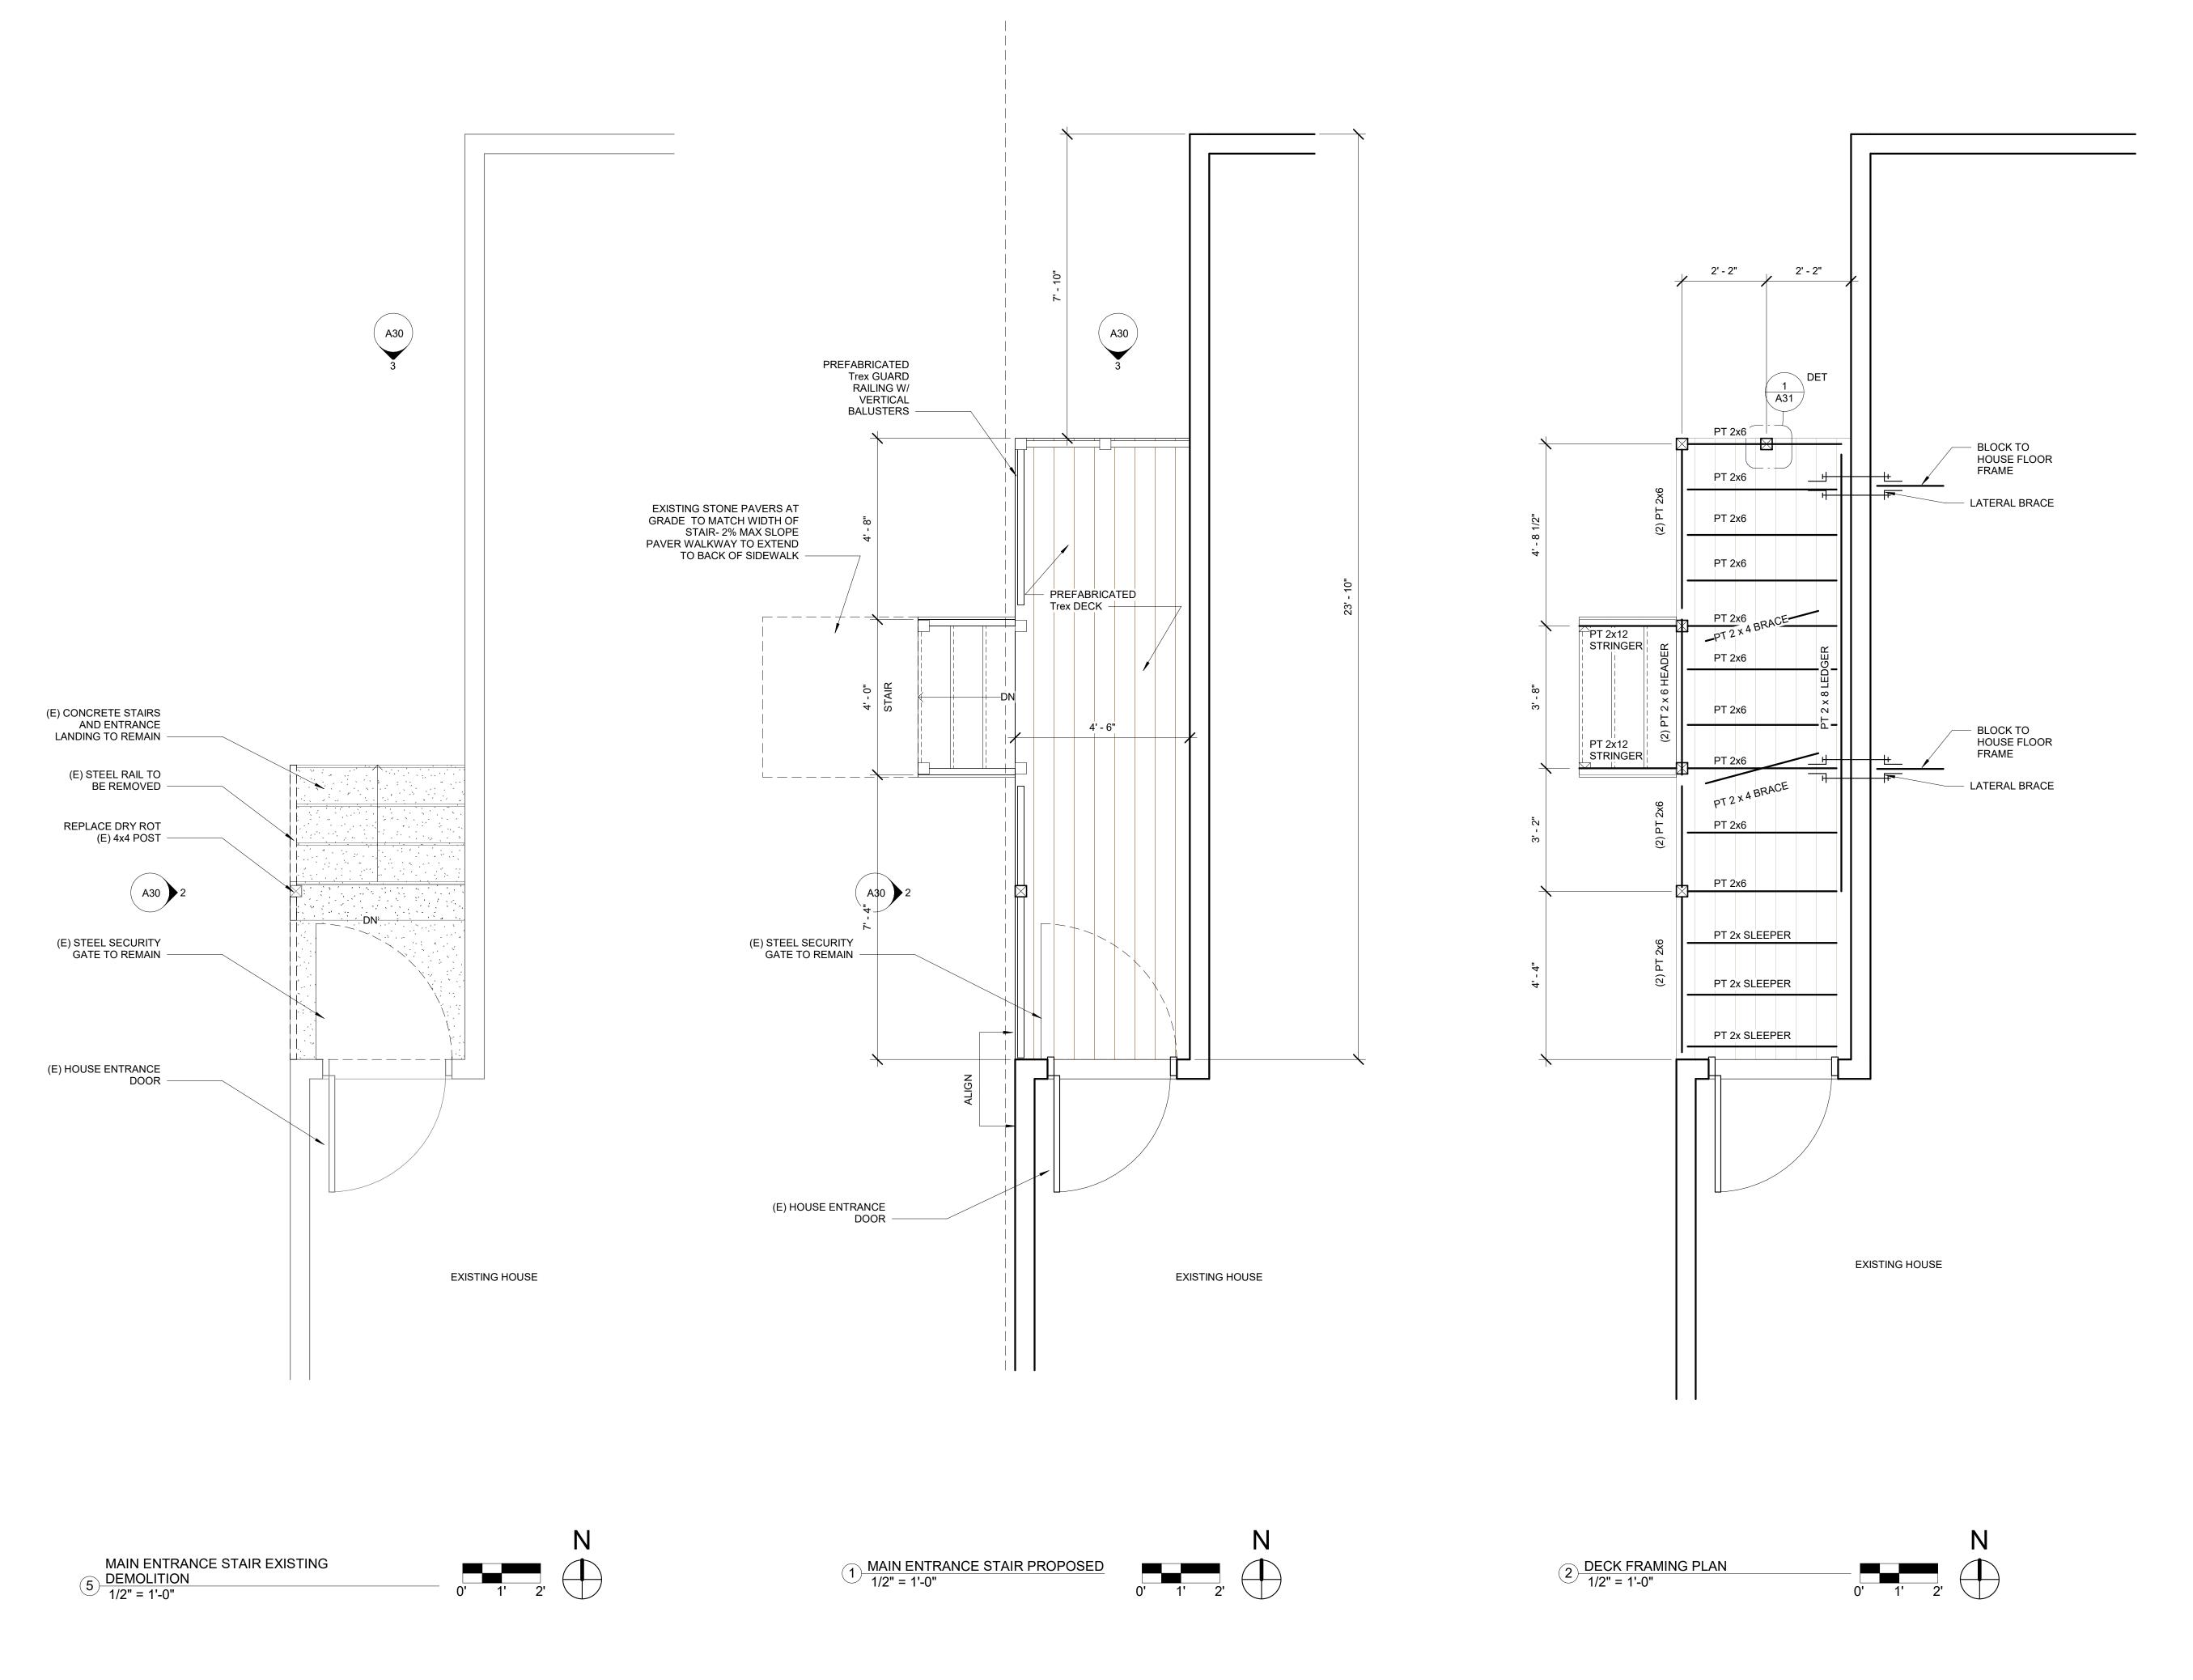

phantomarchitecture

www.phantomarchitecture.com

Owner
1422 Third Street
Alameda, CA 94501
Contact: Mary Hall Patrone
Phone: 510.545.6547
e-mail: mary@littlequilter.com

Architect
PhanTom Architecture Studio
740 Mandana Blvd
Oakland, CA 94610
Contact: Michael R Tom, AIA
Phone: 415.857.5592
e-mail: mtom@phantomarchitecture.com

No. Description Date
PERMIT 06/18/2025



MARY HALL PATRONE DECK 1422 3rd STREET ALAMEDA, CA 94501

ENLARGED DECK FLOOR PLANS

A21Scale 1/2" = 1'-0"


6/21/2025 11:10:36 AM

PRAMED TO WOOD FRAMED TO WOOD

2 DECK WEST ELEVATION (3RD STREET)

1/2" = 1'-0"

0' 1'

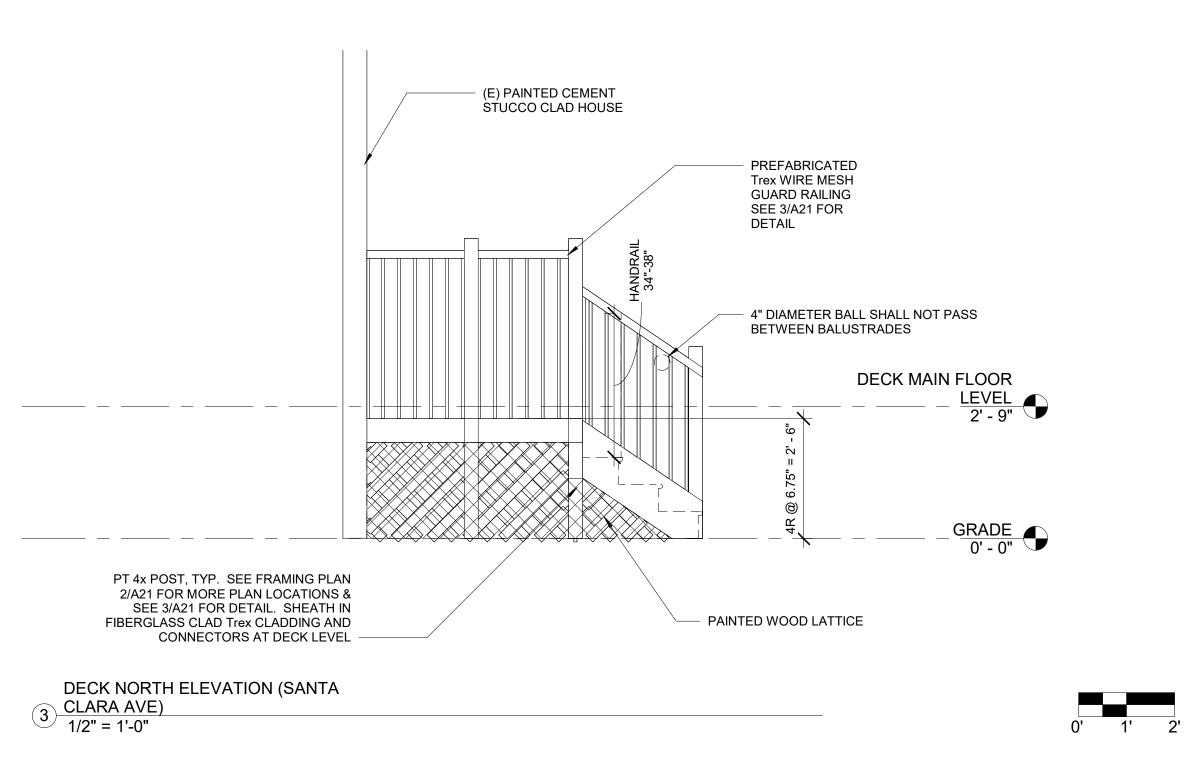


phantomarchitecture

www.phantomarchitecture.com

Owner 1422 Third Street Alameda, CA 94501 Contact: Mary Hall Patrone Phone: 510.545.6547 e-mail: mary@littlequilter.com

Architect
PhanTom Architecture Studio
740 Mandana Blvd
Oakland, CA 94610
Contact: Michael R Tom, AIA
Phone: 415.857.5592
e-mail: mtom@phantomarchitecture.com

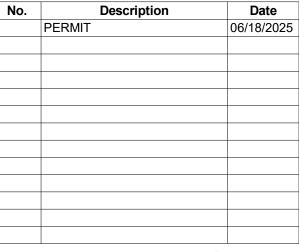





MARY HALL PATRONE DECK 1422 3rd STREET ALAMEDA, CA 94501


ELEVATIONS


A30

1/2" = 1'-0"

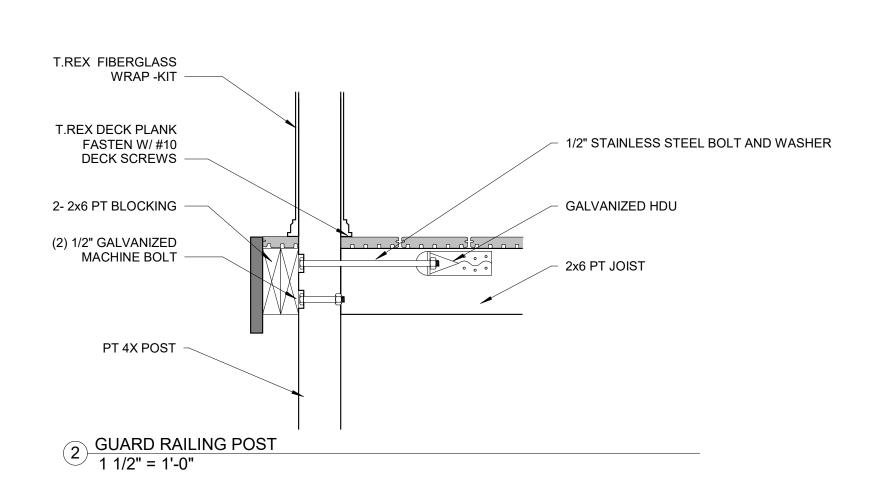

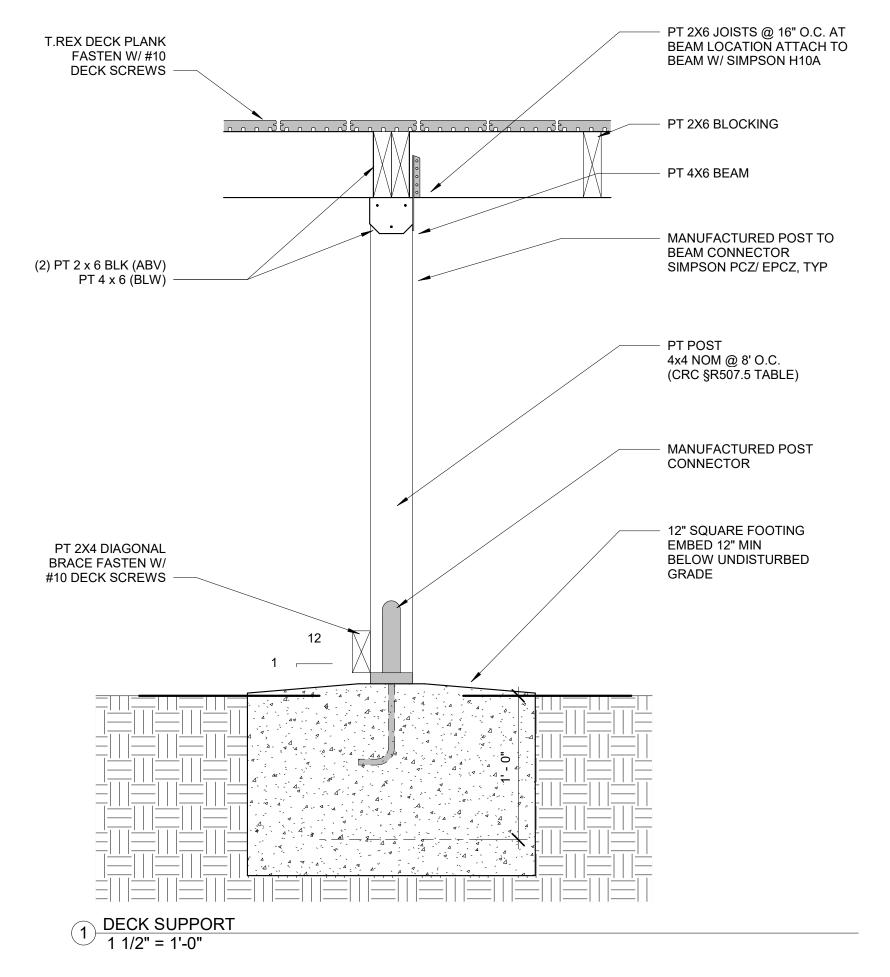

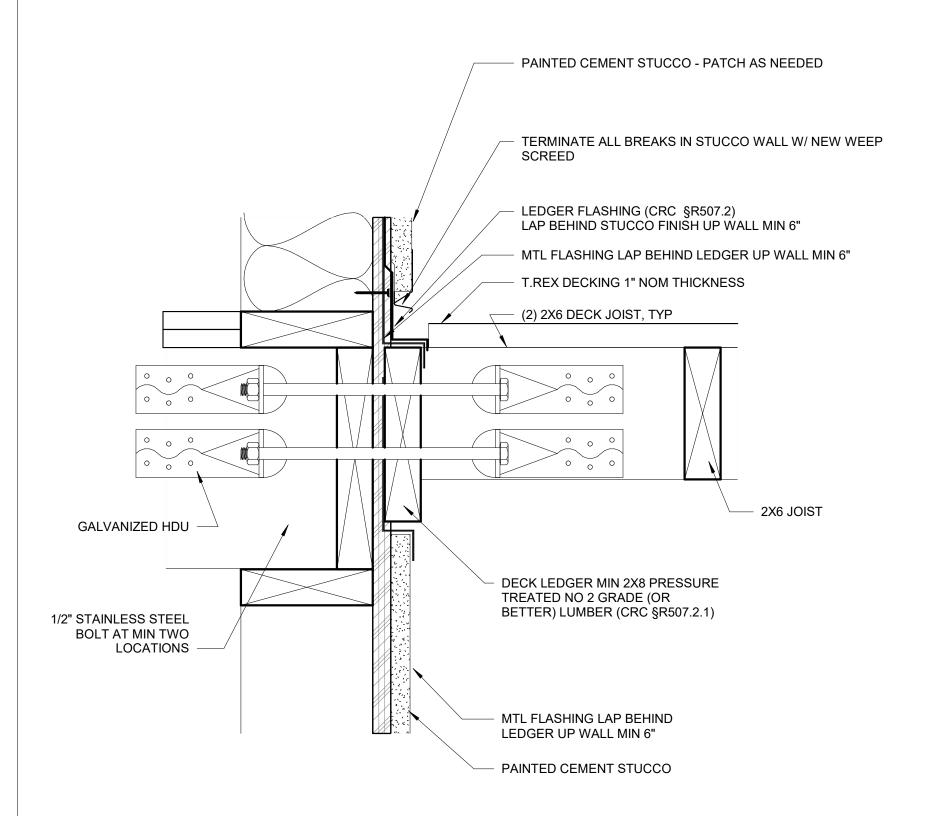

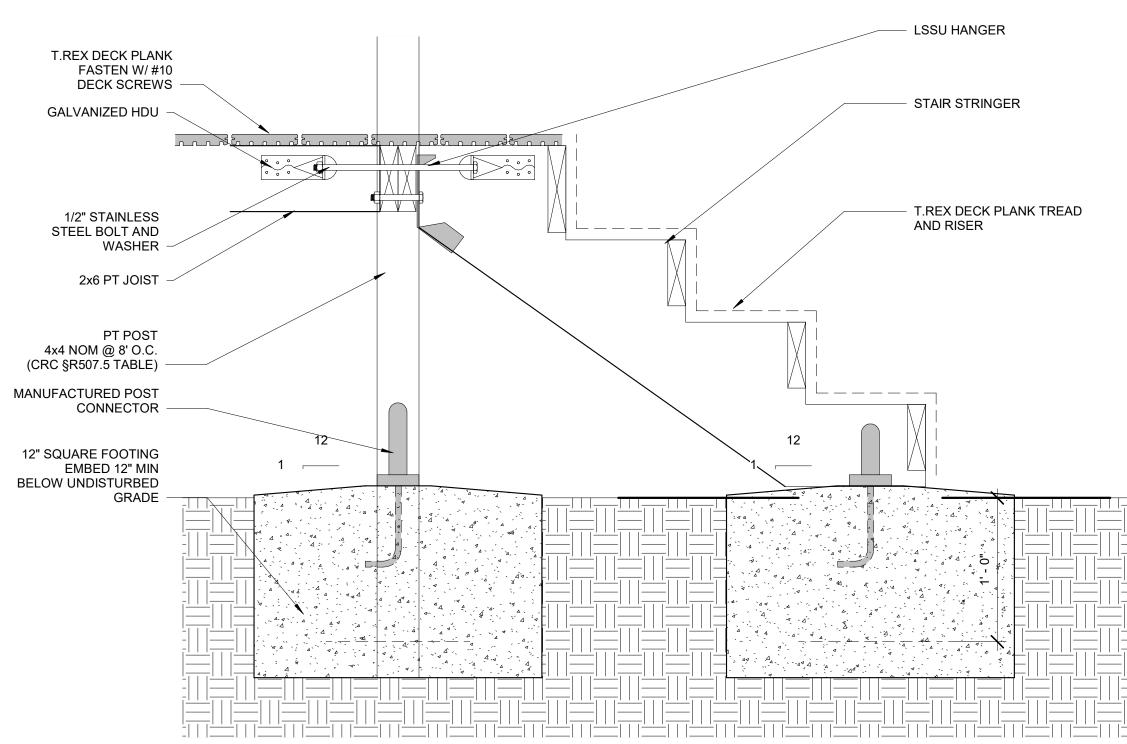


4 LEDGER WATERPROOFING 3" = 1'-0"

3 DECK STAIR 1 1/2" = 1'-0"

ROOFTOP AND SLEEPER DECK SYSTEMS-PRESSURE TREATED FRAMING

A sleeper system is a substructure between a solid surface and Trex decking. Drainage, access, and airflow are critical. Water must be able to flow through and away from the deck. For repairs and removal of debris, joist system access may be necessary.

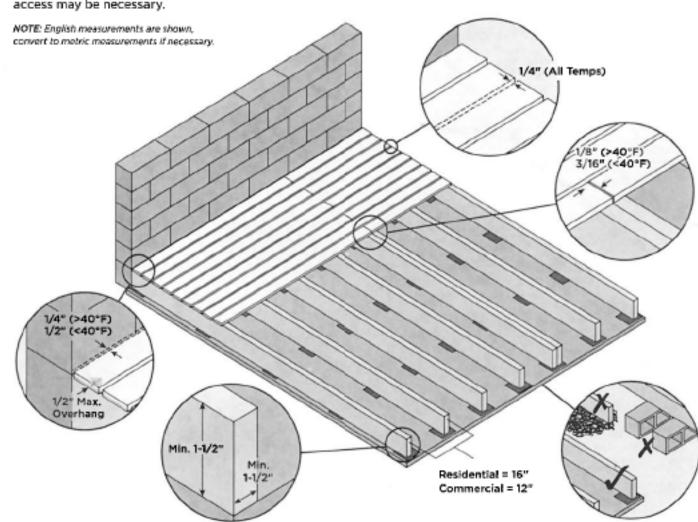

- » It is recommended that building-code-approved structural material be used as the supports. » This system should not be allowed to float; it must
- be attached in a manner that secures the framing/ » The sleeper system must be level and have no uneven undulations. Any uneven areas of the
- substructure will transfer to the Trex decking, resulting in uneven decking. » Trex, when used with a sleeper system, must be supported below its entire length. If using in a roofing application, the supports must run the
- direction of the pitch of the roof to facilitate proper drainage. Sleeper should be placed perpendicular to the deck board orientation. » For commercial applications, consult a local building
- code official for specific requirements. » If installing decking at an angle, decrease spans 4" (100 mm) for each of the above. (12" (305 mm) for residential and 8" (204 mm) for commercial.)
- » For sleeper systems where small debris (pine needles, leaves, sand, dirt) can accumulate either between or under deck boards, a minimum of 1-1/2" (38mm) height is allowable. Trex recommends the use of Trex Universal Hidden Fasteners or 2" Starborn Cap-Tor* xd - Epoxy Coated screws. (NOTE: Trex recommended composite decking screws are too long when using 1-1/2" (38 mm) height as this will penetrate through the sleeper.) For areas with the potential for debris buildup, a minimum 3-1/2" (89 mm) or greater height is recommended to allow the debris to be removed
- along with the use of either Trex Universal Hidden fasteners or any Trex recommended screws. » Always consult your local building code authority for proper details on roof and railing installation to the roof structure if required.
- » Any deviation from these recommendations could result in the voiding of the Trex warranty.

phantomarchitecture

www.phantomarchitecture.com

Owner 1422 Third Street Alameda, CA 94501 Contact: Mary Hall Patrone Phone: 510.545.6547 e-mail: mary@littlequilter.com

Architect PhanTom Architecture Studio 740 Mandana Blvd Oakland, CA 94610 Contact: Michael R Tom, AIA Phone: 415.857.5592 e-mail: mtom@phantomarchitecture.com

27

CODE COMPLIANCE

Joist Spanning for Decking


Trex decking meets all applicable national model building codes. The joists must be spaced on center according to the chart below. Be sure that joists are level and plumb. Trex decking must span at least three joists. For heavy items such as hot tubs, planters, etc., consult a local building engineer or inspector for span recommendations. If you want to minimize the appearance of joists through the spaces between boards, paint the top of your joists black.

Code Listings


Trex complies with major model building codes and has been evaluated by the International Code Council evaluation service.

For a Safety Data Sheet (SDS), please visit WWW.TREX.COM

ADJUST JOIST SPANNING TO ACCOMMODATE ANGLED DECKING PATTERNS

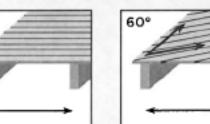

Perpendicular to joists. See chart below.

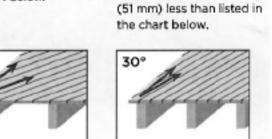

joist spanning is 4"

in the chart below.

At a 60° angle, maximum

joist spanning is 2"

At a 45° angle, maximum At a 30° angle, maximum joist spanning is 1/2 of (102 mm) less than listed the distance listed in the chart below.

| | TREX DECKING SPAN CHART (On Ce | nter) | |
|---|---|---|---------------------|
| | Residential Decks, Light Duty Docks, Residential/Day Care Playground | Commercial Decks, Boardwalks and Marinas | |
| Decking Loading | 100 psf = 4.8 kN/m2 | 100 psf = 4.8 kN/m2 | 200 psf = 9.5 kN/m2 |
| 1" (25 mm) Boards (including Porch), and .875" (22 mm) Select Boards | 16' (406 mm) | 16" (406 mm) | 12" (305 mm) |
| 2" x 6" (51 mm x 152 mm) Boards | 24" (610 mm) | 24" (610 mm) | 16" (406 mm) |

| TREX RAILING SPANICHART | | |
|--|--|--|
| Maximum Railing Span for all Applications | | |
| Transcend, Select railing, and Trex® Signature™ railing | 96" on center (2438 mm) for Transcend, 72" on center (1829 mm) for Select, 96" (2438 mm) clear span for Trex® Signature™ | |

Date Description



MARY HALL PATRONE DECK 1422 3rd STREET ALAMEDA, CA 94501

TREX DECK

As indicated

NOTE: Construction methods are always improving. Please refer to www.trex.com for the most up-to-date installation requirements.